



Lots 8001-8025

Cancelling Lots 5000 on SP283208 \$ Lot 5001 on SP268596

# STAGE 801

Total Site Area ...... 2.24 ha

Parish of Bohle County of Elphinstone City of Townsville


Average Lot Area..... 556m²

Total Length of New Road .... 529m

─ 1.5m path

1.0m contour

0.5m contour

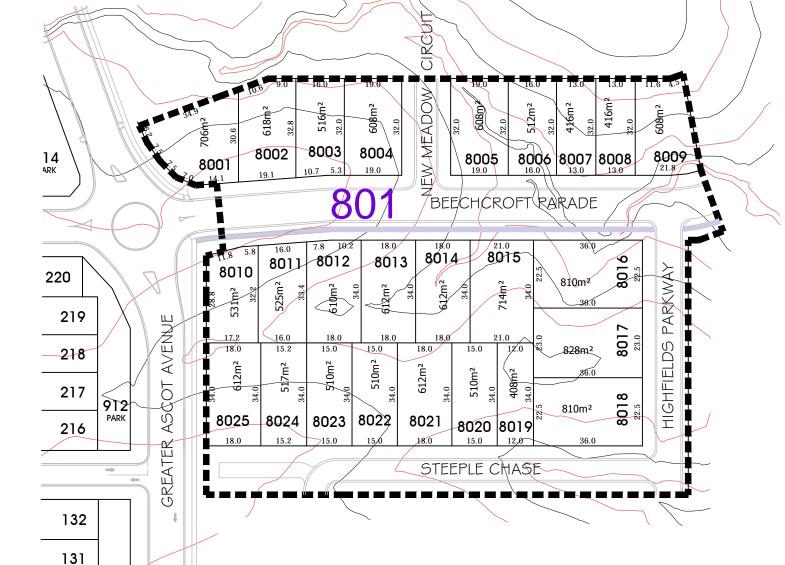

# **Notes**


Corner Sight Lines:

Comply with sight lines requirement of the Queensland Development Code on road corners.

This is typically 9m x 9m exclusion zone based

For clipped corners and lots with park frontages typically this is a 18m x 18m exclusion zone based on the edge of the traffic lane.

Rear access lanes are exempted from this requirement.

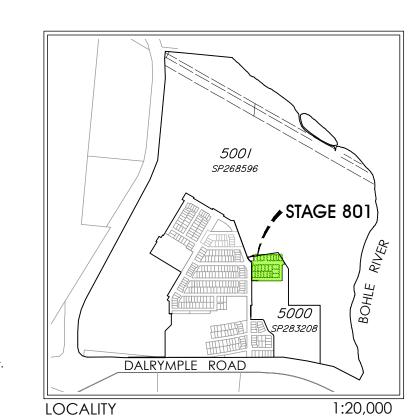

brazier moπi



907

130

129

128







13th September, 2017 scale -nber - 26700/212-01 sheet file name - 26700\_158B.dwg drawn -

DRAWING TITLE PROPOSED **RECONFIGURATION** 

DRAWING NUMBER 26700/158 B



**Developers Note** 

Building Envelope Plans are created as a design tool only. House siting must comply with Precinct Plan and Lot Specifications Drawing 26700/157D

## **BUILDING ENVELOPES** POSSIBLE BUILT TO BOUNDARY WALL MAX

9m LONG AND APPLICABLE TO GARAGE OR

CLASS 10A BUILDINGS ONLY WHICH SHALL CONFORM TO THE REQUIREMENTS OF THE

QUEENSLAND DEVELOPMENT CODE INDICATIVE BUILDING ENVELOPE ALLOWABLE DRIVEWAY ACCESS STORMWATER DRAINAGE LINE SUBSOIL DRAIN & CLEANOUT POINT

WATER MAIN, FIRE HYDRANT & VALVE

POLYETHYLENE WATER MAIN

PREFERRED DRIVEWAY LOCATION

SEWER MAIN & MANHOLE

1. THE BUILDING ENVELOPES ARE TO COMPLY WITH THE DESIGN CODE SHOWN ON THIS PLAN. GREATER SETBACKS MAY BE REQUIRED TO ACCOMMODATE THE ZONE OF INFLUENCE OF UNDERGROUND SERVICES AS STATED IN COUNCIL'S POLICY ON BUILDING OVER OR ADJACENT TO SEWERS.

INDICATIVE BUILDING ENVELOPES SHOWN ARE QDC GROUND DWELLING ONLY AND DO NOT ACCOUNT FOR BATTERS OR

RETAINING WALLS. A SITE INSPECTION IS REQUIRED PRIOR TO COMMENCEMENT OF DESIGN. REFER DESIGN CODE FOR UPPER FLOOR AND GARAGE SETBACKS.

# **CORNER SIGHT LINES**

- 1. COMPLY WITH SIGHT LINES REQUIREMENT OF THE QUEENSLAND DEVELOPMENT CODE AT INTERSECTIONS OF ROADS. INTERSECTIONS OF LANES AND ROADS ARE EXEMPTED FROM THIS REQUIREMENT.
- 2. THE OUEENSLAND DEVELOPMENT CODE TYPICALLY REQUIRES A 9mx9m EXCLUSION ZONE BASED ON BOUNDARIES.

# NOISE FENCE **DRIVEWAY ACCESS ENVELOPES**

**LEGEND** 


- FOR DRIVEWAY ACCESS ENVELOPES ALLOW 0.5m MINIMUM CLEARANCE TO ALL COUNCIL INFRASTRUCTURE, EXCEPT STORMWATER PITS WHICH REQUIRE 0.6m MINIMUM CLEARANCE, AND SEWERAGE HOUSE CONNECTIONS WHICH REQUIRE 1.2m CLEARANCE.
- ALL DRIVEWAYS REQUIRE A PERMIT FROM COUNCIL PRIOR TO CONSTRUCTION.

#NOTE: OUTBUILDING (CARPORT/GARAGE) - THE BALANCE OF THE LOT BOUNDARY ADJACENT TO THE OUTBUILDINGS WHERE LOCATED ALONG A ROAD RESERVE INCLUDING LANES) MUST REMAIN OPEN WITH NO ADDITIONAL STRUCTURES PERMITTED ALONG THAT BOUNDARY (EXCLUDING BOUNDARY FENCING WHICH ALLOWS AIRFLOW THROUGH THE BARRIER). NOTE: CLEARANCES TO SEWER LINES AND MANHOLES ARE REQUIRED IN ACCORDANCE WITH COUNCIL POLICY.


LIGHT POLES & TELSTRA PITS HAVE NOT BEEN SHOWN

# **DESIGN CODE - ALL ALLOTMENTS**

TYPE	HOUSE, FRONT LOADED
LOT ACCESS	FRONT, FROM STREET
LOT DEPTH (MIN)	25m (20m WHERE 15m WIDTH PROPOSED)
LOT WIDTH (MIN)	12.5m
SITE COVERAGE	55% MAX
SETBACK FRONT GROUND (MIN)	3.5m
SETBACK FRONT UPPER (MIN)	3.5m
SETBACK FRONT GARAGE	6.0m FROM FRONT OF GARAGE WALL & 1.5m MIN FROM DWELLING
SETBACK PRINCIPAL SIDE GROUND (MIN)	QDC
SETBACK PRINCIPAL SIDE UPPER (MIN)	QDC
SETBACK ROAD/ROAD CORNER (MIN)	2.0m
SETBACK PRINCIPLE REAR (MIN)	3.0m
OUTBUILDING # (CARPORT/GARAGE) WIDTH (MAX FROM OUTSIDE WALL)	N/A
OUTBUILDING # (CARPORT/GARAGE) & RESIDENTIAL OVER OUTBUILDING SETBACK TO LANE	N/A
OUTBUILDING # (CARPORT/GARAGE) & RESIDENTIAL OVER OUTBUILDING SIDE SETBACK OTHER THAN TO LANE (MIN)	ODC
OUTBUILDING (SHED) WIDTH (MAX)	LESSER OF 50% OF REAR BOUNDARY OR 9m
OUTBUILDING (SHED) DEPTH (MAX)	QDC
OUTBUILDING (SHED) REAR SETBACK	0-1.0m
OUTBUILDING (SHED) SIDE SETBACK	QDC
FLOOR HEIGHT PRINCIPAL (MIN)	400mm
MAXIMUM STOREYS	2 STOREYS
PRIVATE OPEN SPACE (MIN) (MAY BE COVERED)	4mx4m
PARKING (MIN)	TWO (2), ONE OF WHICH MUST BE COVERED

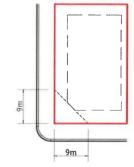

STANDARD CORNER BUILDING SETBACK

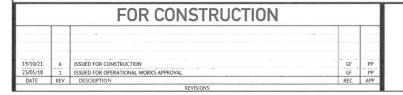




DESIGNED AJOUBERT CHECKED (CL.)	SCALE			
G.FYSH PROJECT MANAGER P.PETERSEN		10	20	30m
ENGINEERING CERTIFICATION P.PETERSEN RPEQ 13231	] =		:500 (A1)	
PROJECT DIRECTOR	ORIGINAL SHEET SIZE A1			


	CLIENT	PARKSIDE DEVELOPMENT PTY LTD
	PROJECT	GREATER ASCOT STAGE 801 & 802
m	LOCATION	GREATER ASCOT, SHAW
4	SHEET TITL	LOT CONSTRAINTS PLAN - SHEET 1 OF 2


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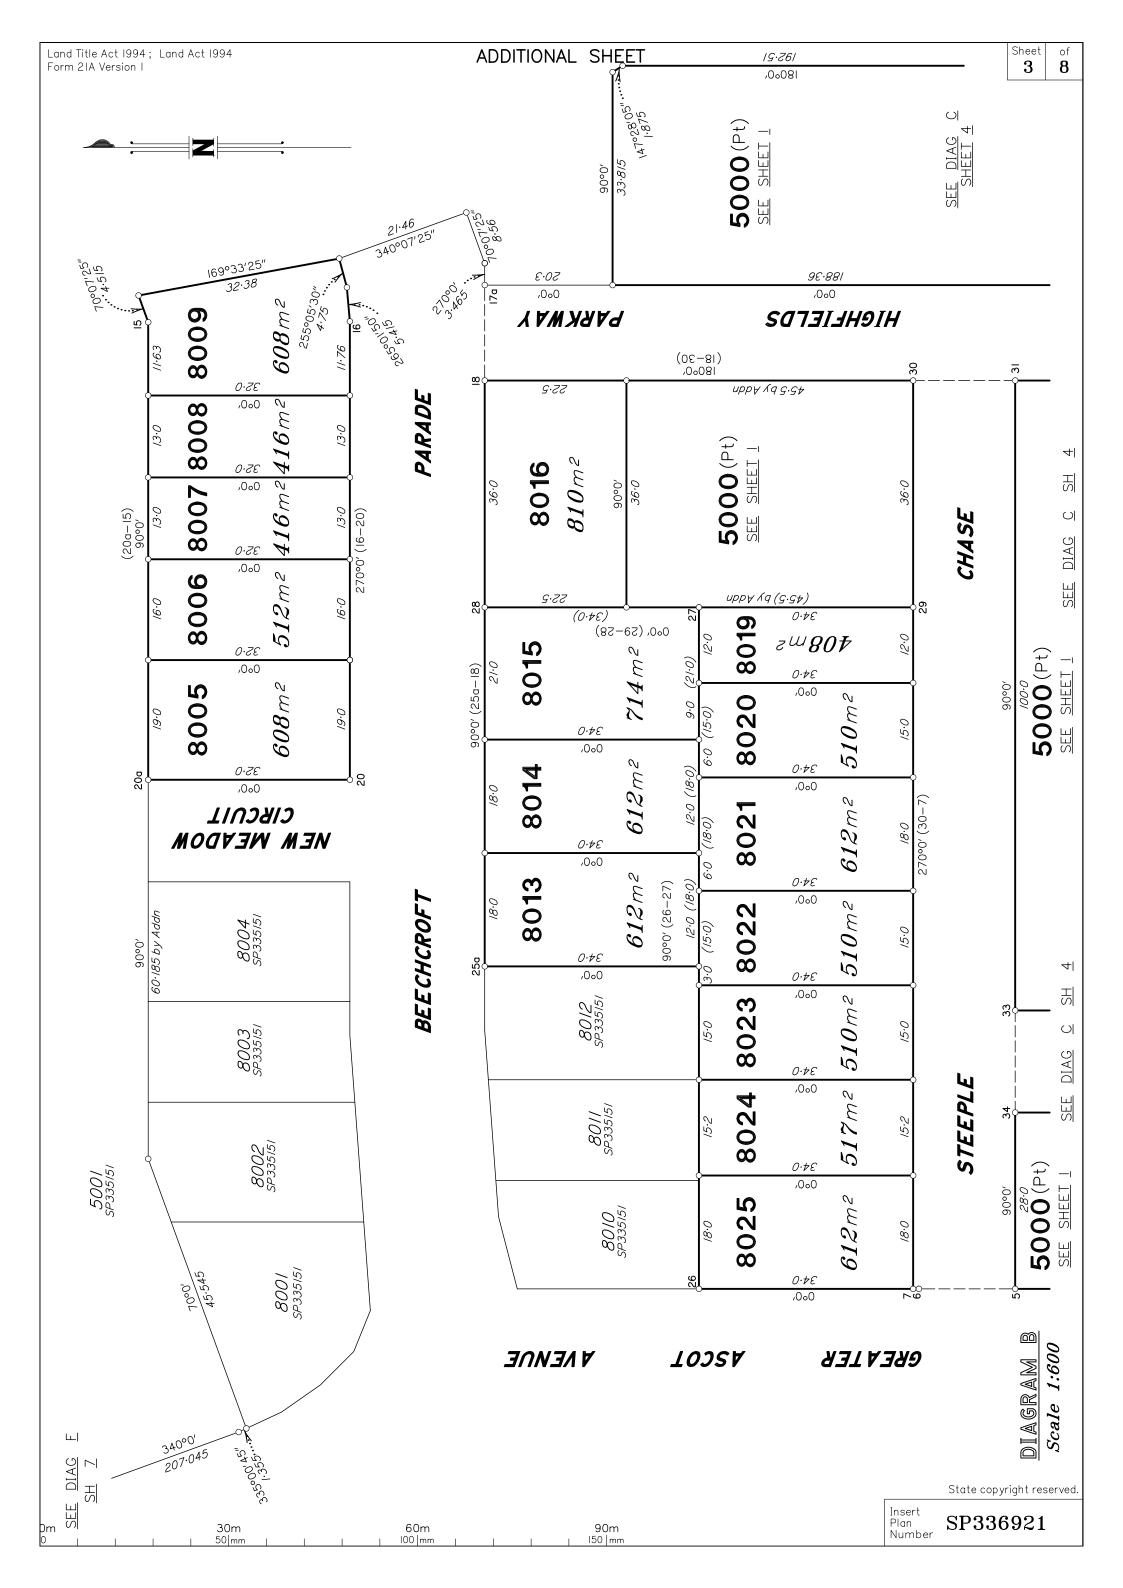


Land Title Act 1994;Land Act 1994 Form 21B Version 2		WARNING: Folded or Mutilated Plans will not be Plans may be rolled.  Information may not be placed in the outer n	ns will not be accepted. 2 9 rolled.
۵)	(Dealing No.)		
		(Include address, phone number, email, reference, and Lodger Code)	nd Lodger Code)
Title Reference	Description	New Lots	Oregied Road Secondary Interests
51114701	Lot 5000 on SP295380 Lot 5001 on SP331005	8001-8004, 8010-8012, 5000 & 5001 8001-8004, 5000 & 5001	New Rd
Edsement  601363709 (Emt A on RP743622) 601363708 (Emt C on RP719917) 601398181 (Emt D on RP719916) 709012260 (Emt E on SP175714) 7090122813 (Emt P on SP257312) 715322813 (Emt P on SP257312)	EASEMENT ALLOCATIONS  Lots to be Encumbered 3622) 3622) 5001 5001 573(4) 5001 5000 53(2) 53(2) 53(2) 53(2) 53(2) 53(2) 53(2) 54(2) 55(2) 5		
			6. Building Format Plans only.  I certify that:  * As far as it is practical to deterpane, no part of the building shown on this plan encroaches onto adjoining lots or road;  * Part of the building shown on this plan encroaches onto adjoining * lots and road  Cadostral Surveyor/Director*  Date
8001–8004, 8010–8012 5001 5000	Por 418 Pors 6V, 33, 227, 243, 418 & 497 Pors 33, 418 & 227		
Lots	Orig		New Titles
2. Orig Grant Allocation :		5. Passed & Endorsed:	
<ul><li>3. References:</li><li>Dept File:</li></ul>		By: BRAZIER MOTTI PTY LTD Date: 15-96-22	TOTAL \$
Local Govt : Surveyor : 26700/227-02 - 26700	26700_243A.dwg - WCHO - 01/2022 - V0	Sign of: Liaison Officer	8. Insert Plan Number

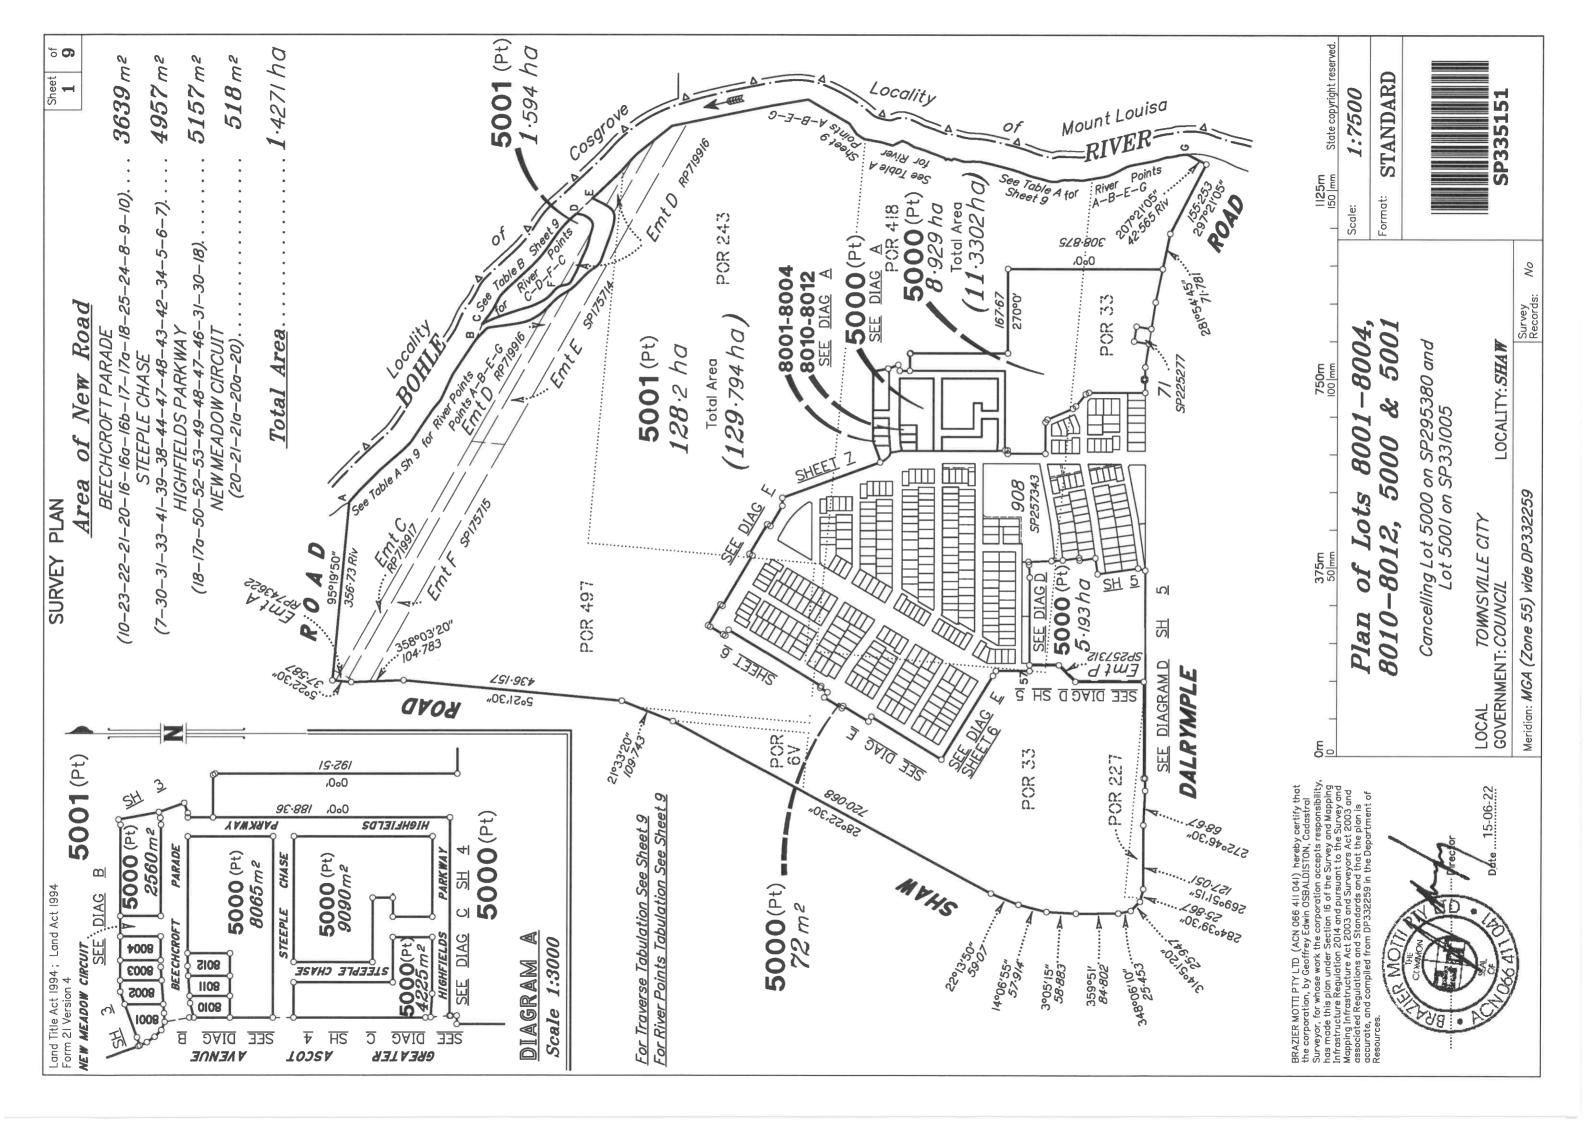


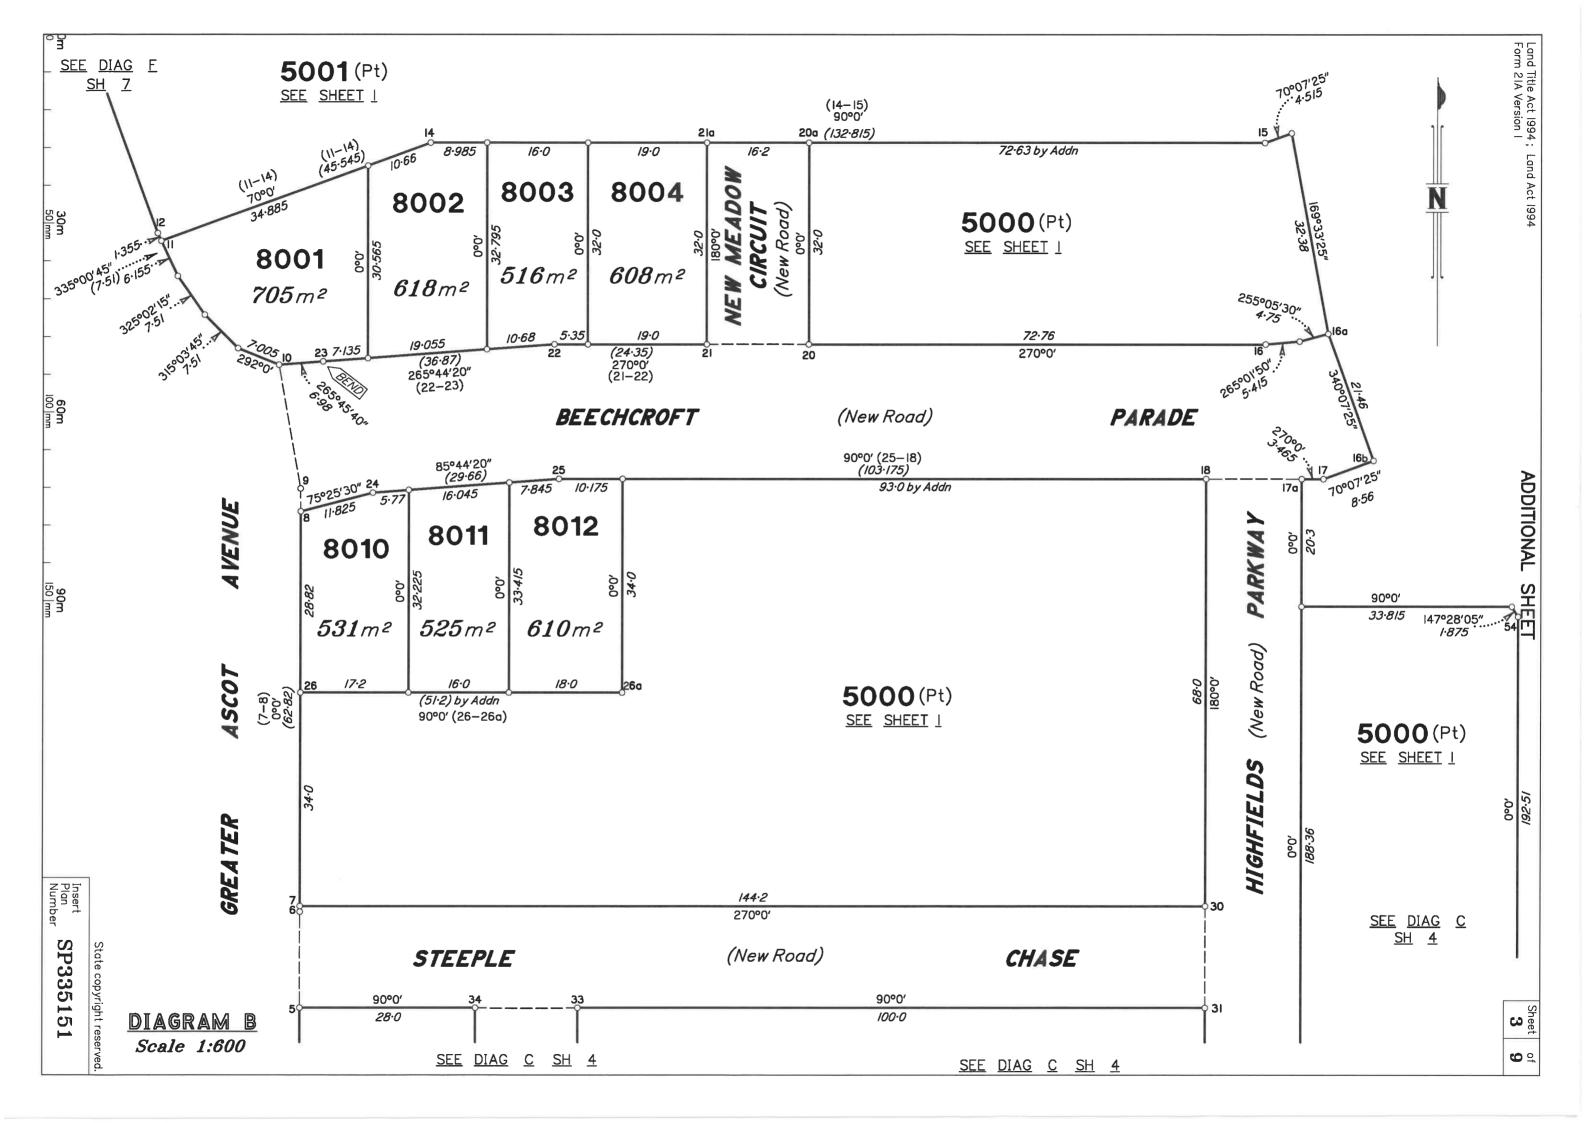

Title Reference	isting	(Include address, phone number, email, reference			WARNING: Folded or Mutilated Plans will not be accepted.  Plans may be rolled.  Information may not be placed in the outer margins.  4. Lodged by		
Title Reference	isting		e, and Lodger Code)				
Reference			Created				
51289947	Description	New Lots		Road	Secondary Interests		
	Lot 5000 on SP335151	8005-8009, 8013-8016, 8019-802	:5 <b>&amp;</b> 5000				
ENCUMBRANCE EAS Easement	EMENT ALLOCATIONS Lots to be Encumbered						
715322813 (Emt P on SP257312)							
			of the building onto adjoining * Part of the	: is practical g shown on g lots or roo building sho nto adjoinin rveyor/Direc not required	to determine, no part this plan encroaches ad, own on this plan ng*lots and road ctor* Date		
8005-8009, 8013-8016, 8019-8025			Survey Dep	posit	\$		
5000	Pors 33, 227 & 418		Lodgemen New T		\$ \$		
	Orig				\$		
Lots			─ Photocop\	У	\$		
2. Orig Grant Allocation :		5. Passed & Endorsed :	Photocopy Postage	у	\$ \$		
<ul><li>2. Orig Grant Allocation :</li><li>3. References :</li></ul>		By: BRAZIER MOTTI PTY LTD		у	\$		
2. Orig Grant Allocation :			Postage	у	\$		

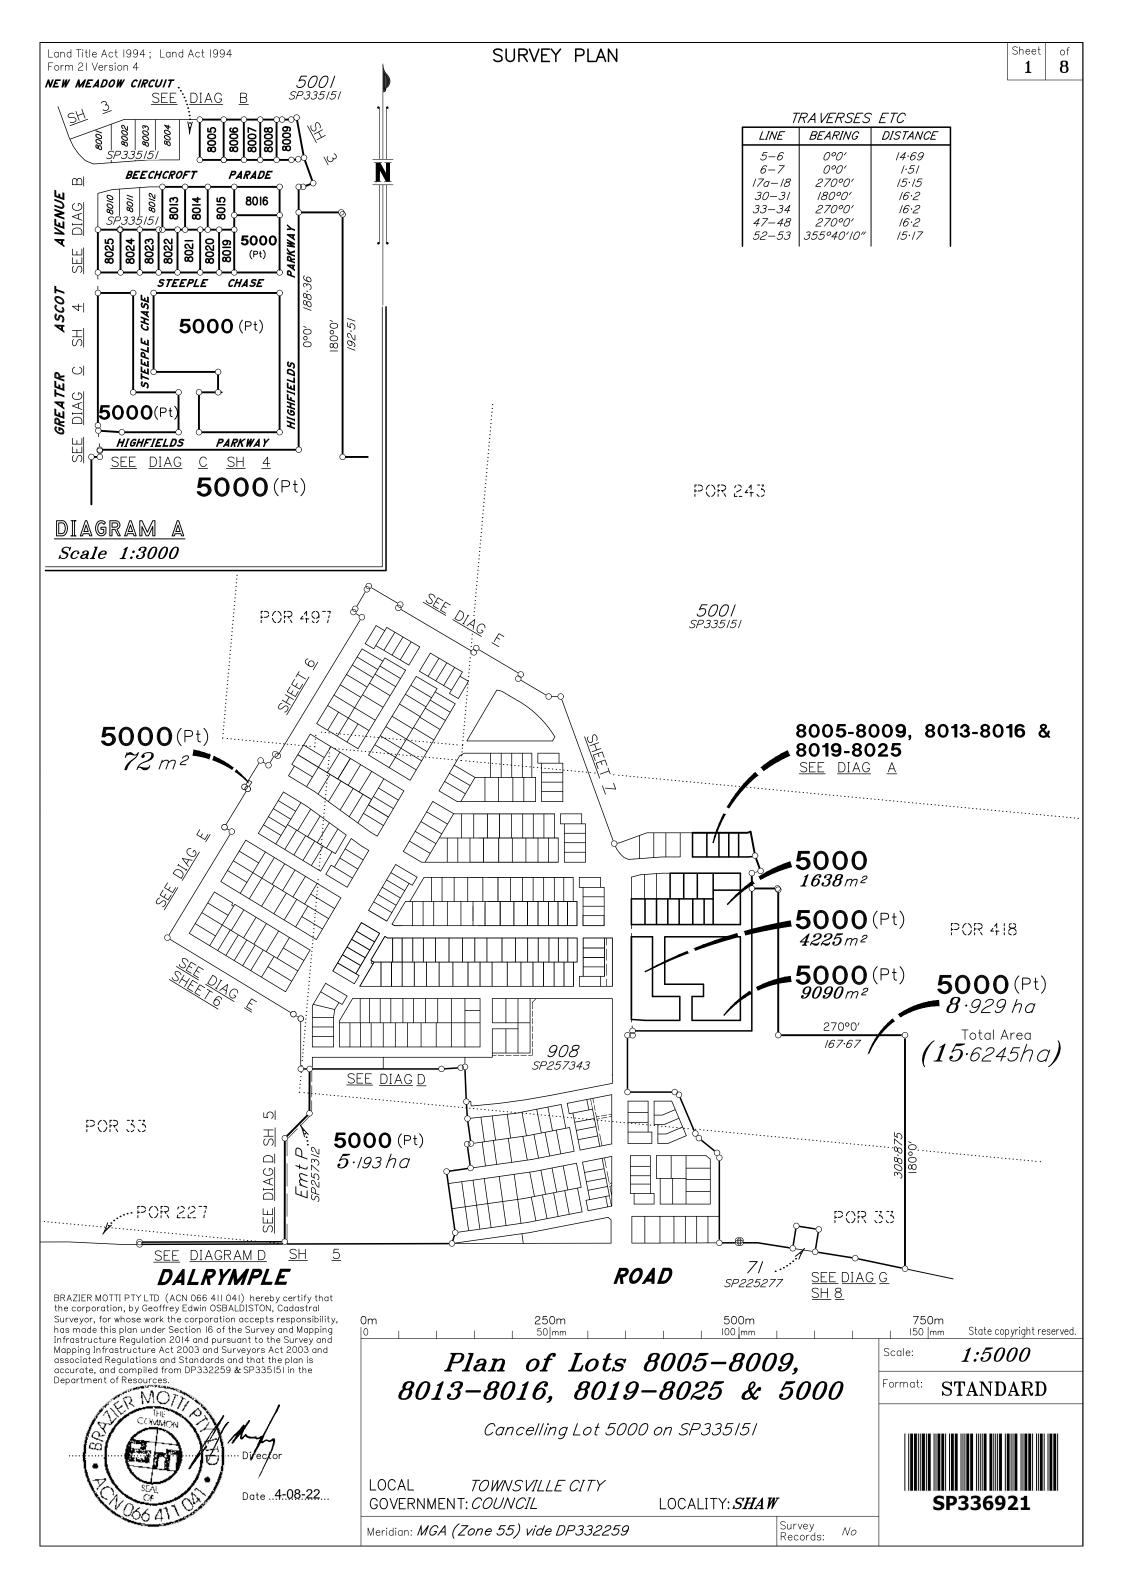

# GREATER ASCOT STAGE 801 & 802 GREATER ASCOT, SHAW FOR PARKSIDE DEVELOPMENT PTY LTD

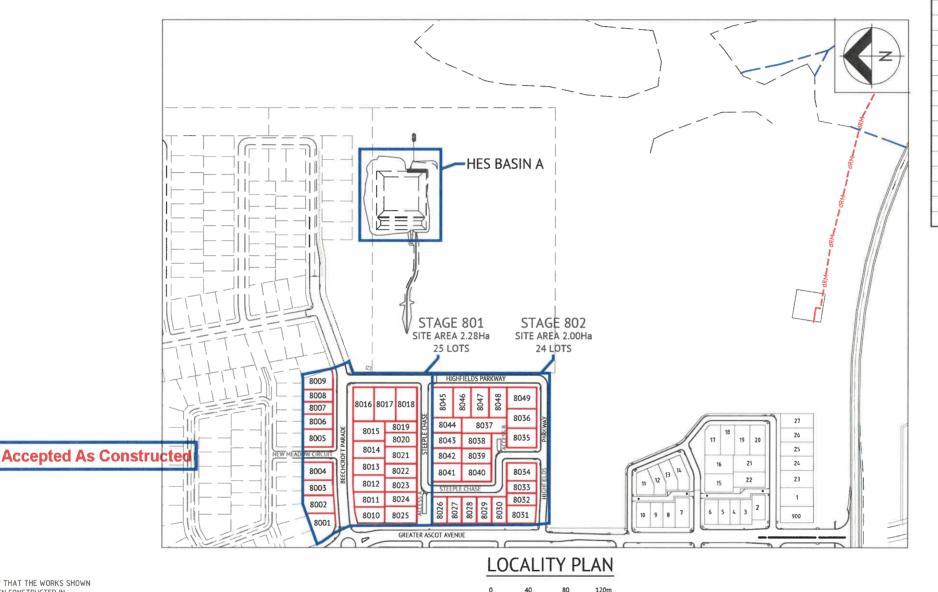

SCALE 1:2000 (A1)

DRAWING SCHEDULE Sheet Number Sheet Title COVER SHEET LOCALITY PLAN & DRAWING SCHEDULE EARTHWORKS LAYOUT PLAN ROADWORKS AND STORMWATER DRAINAGE PLAN 226 HIGHFIELDS PARKWAY LONGITUDINAL AND CROSS SECTIONS 227 BEECHCROFT PARADE LONGITUDINAL AND CROSS SECTIONS 228 STEEPLE CHASE LONGITUDINAL AND CROSS SECTIONS 229 NEW MEADOW CIRCUIT LONGITUDINAL AND CROSS SECTIONS 230 ROADWORKS DETAILS PLAN - SHEET 1 OF 2 231 ROADWORKS DETAILS PLAN - SHEET 2 OF 2 232 LINEMARKING DETAILS PLAN 233 Q2 STORMWATER LONGITUDINAL SECTION - SHEET 1 OF 2 234 Q2 STORMWATER LONGITUDINAL SECTION - SHEET 2 OF 2 WATER AND SEWERAGE RETICULATION PLAN 236 WATER DETAILS 237 HES BASIN PLAN HES BASIN DETAILS PLAN

TOWNSVILLE EARTHMOVING DO HEREBY CERTIFY THAT THE WORKS SHOWN ON THE 'AS CONSTRUCTED' DRAWINGS HAVE BEEN CONSTRUCTED IN ACCORDANCE WITH THE DRAWINGS AND CONTRACT DOCUMENTS APPROVED BY COUNCIL FOR THE CONSTRUCTION OF THE PROJECT.

AUTHORISED DELEGATE DATE 10/06/22



PREMISE DO HEREBY CERTIFY THAT THE WORKS AS SHOWN ON THE 'AS CONSTRUCTED' DRAWINGS REFLECT ANY CHANGES THAT WERE MADE DURING THE COURSE OF CONSTRUCTION.

RPEQ 13231 DATE 14-96-22

1	BRAZIER MOTTI PTY LTD (ACN 066 411 041), 595 Flinders Street, Townsville hereby certify that this Drawing accurately and correctly describes and records the nature and location of the works depicted I
	actoricks (*) berney as thou have been constructed for subdivision




#### PARKSIDE DEVELOPMENT PTY LTD


AS CONSTRUCTED - GREATER ASCOT STAGE 801 & 802
GREATER ASCOT AVENUE - SHAW
LOCALITY PLAN, SITE PLAN & DRAWING SCHEDULE

Local Authority: Townsville City Council


VING SCHEDULE



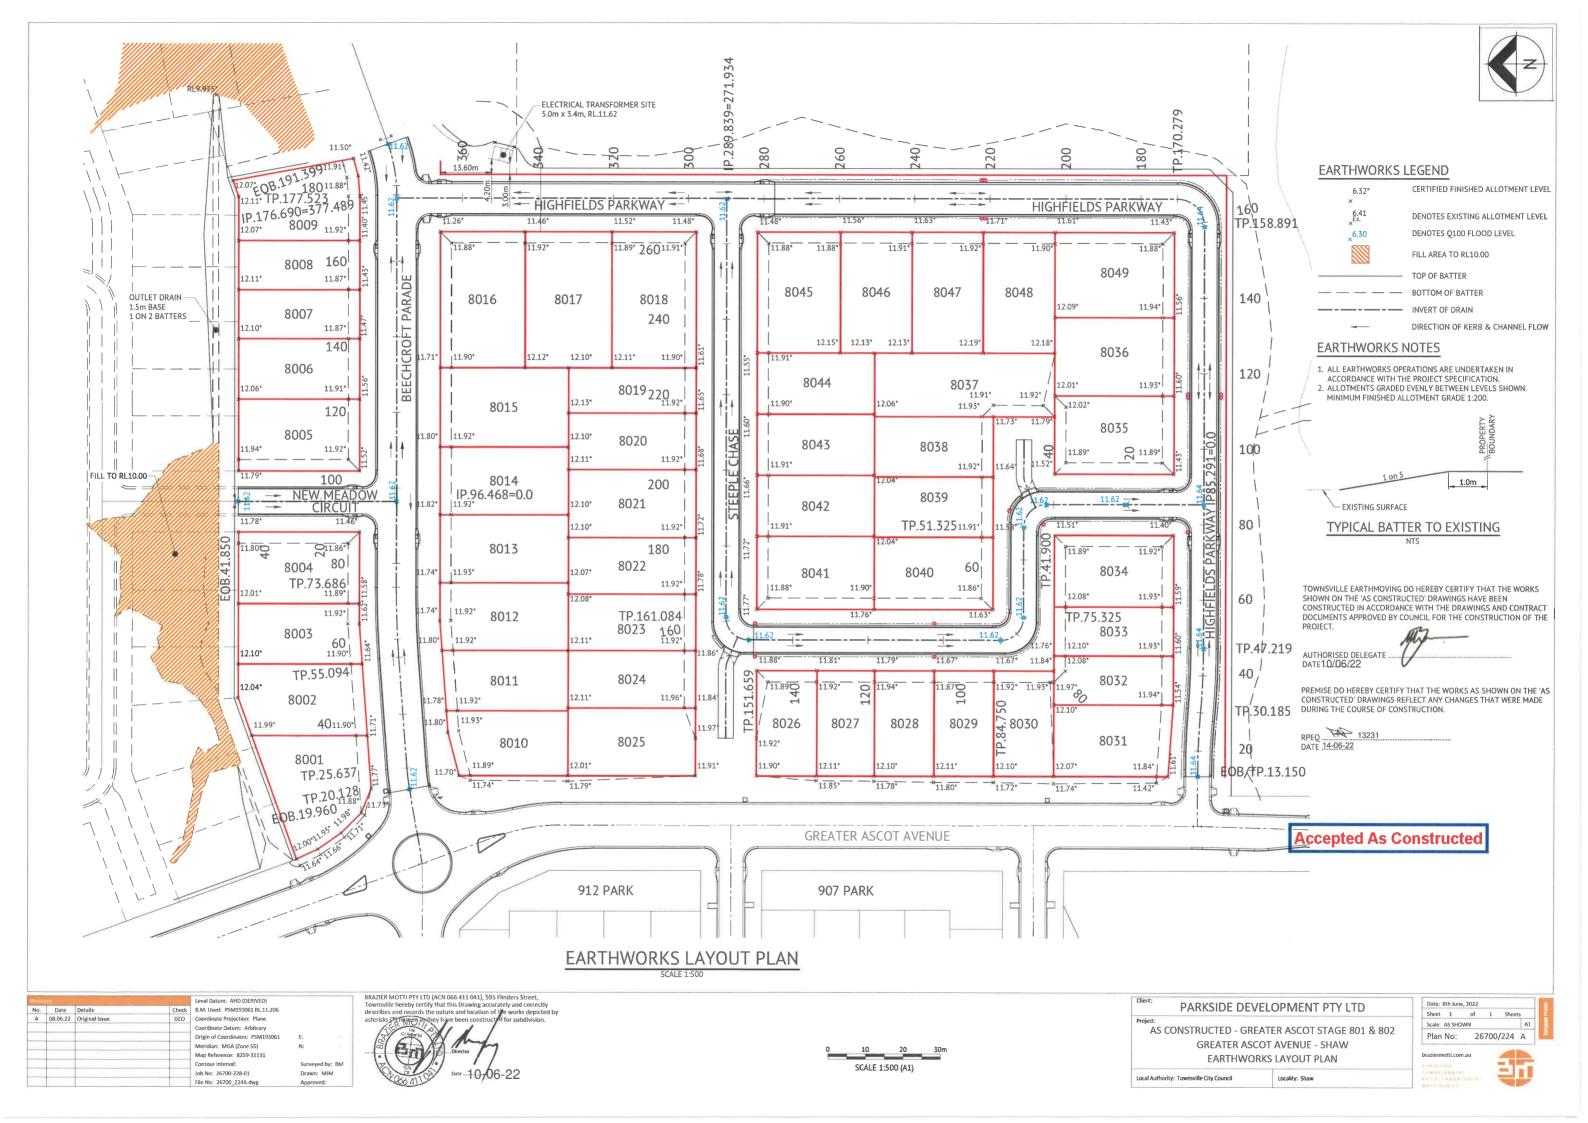

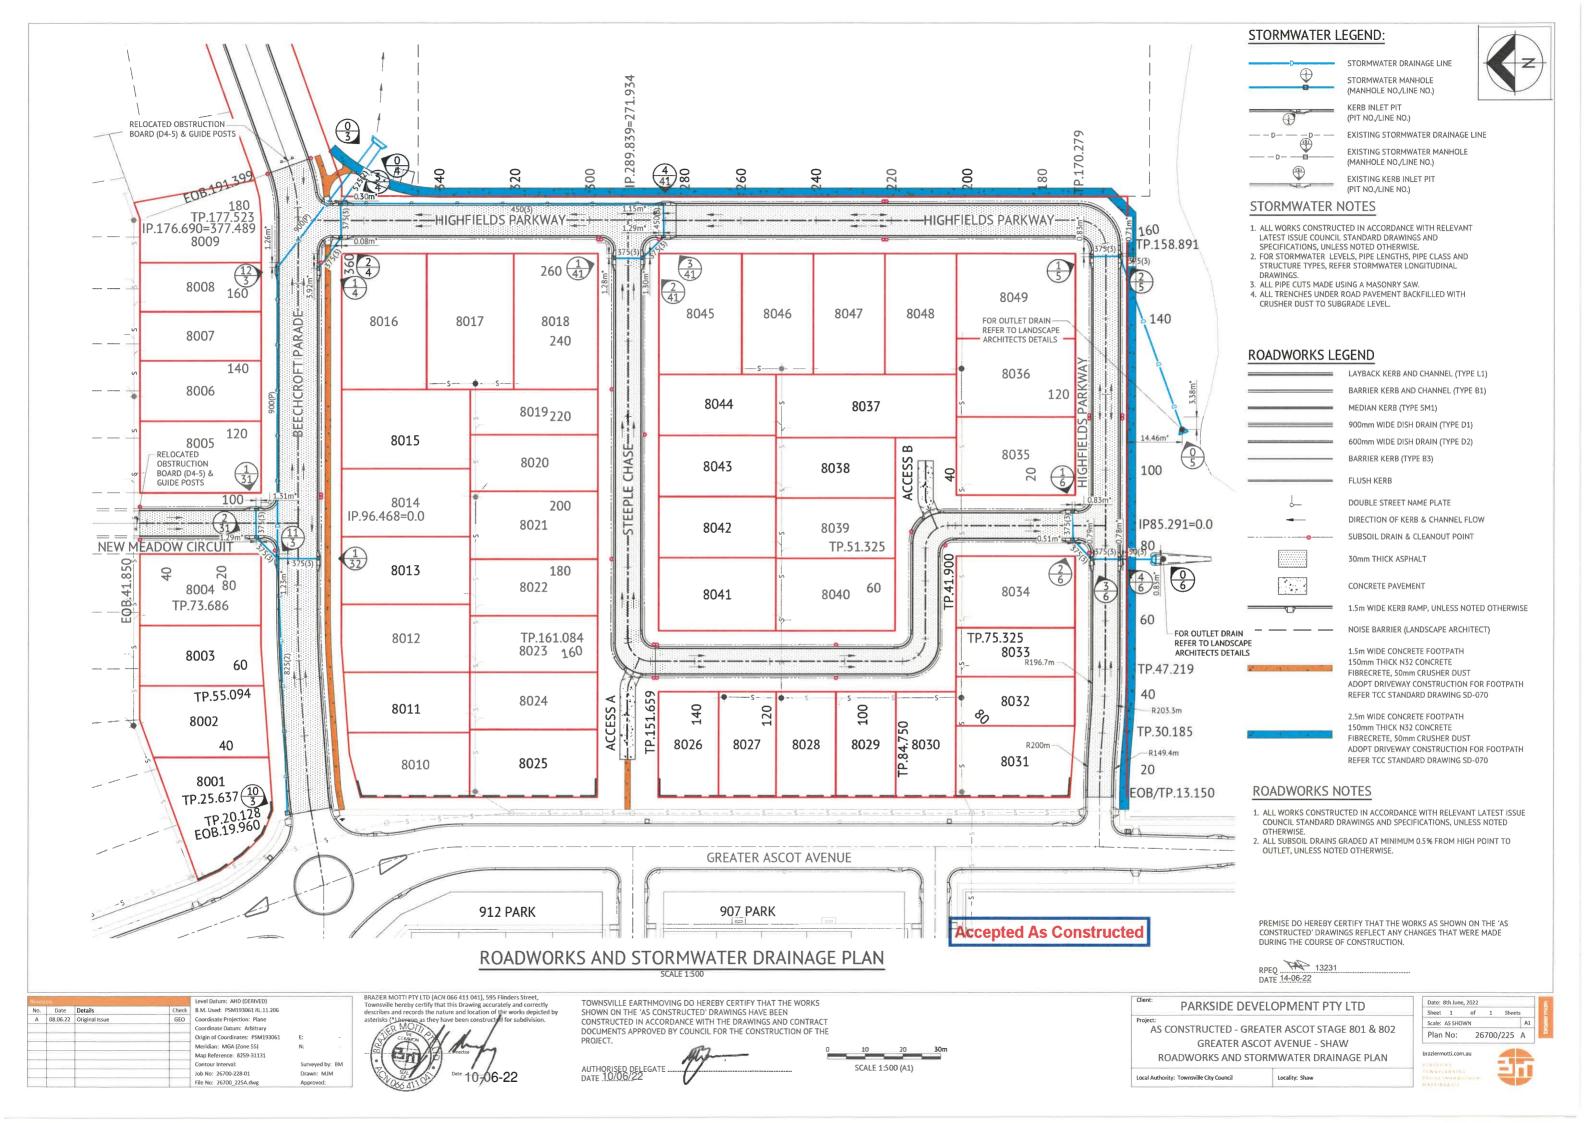



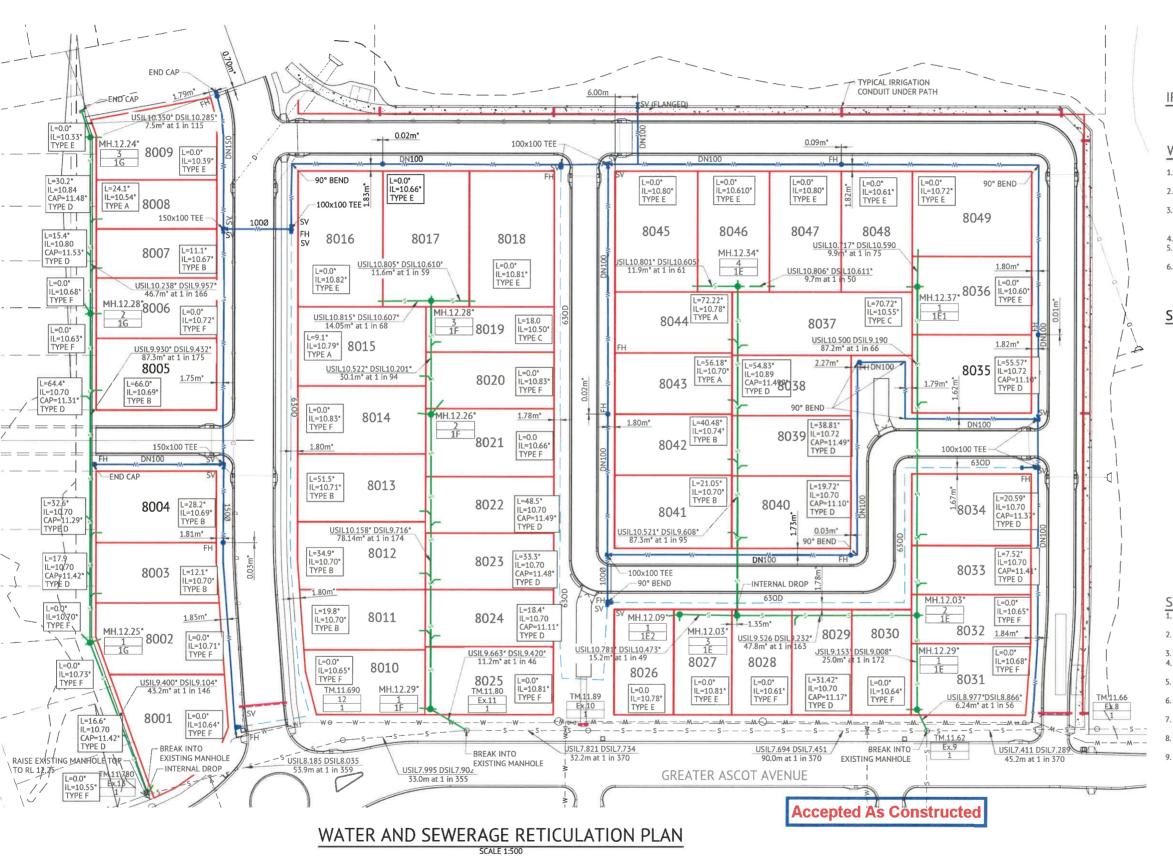

#### WATER LEGEND

WATER MAIN AND DIAMETER 630D POLYETHYLENE WATER MAIN AND DIAMETER FIRE HYDRANT, VALVE AND REDUCER EXISTING WATER MAIN, VALVE AND HYDRANT

#### IRRIGATION CONDUITS LEGEND

DN100 CONDUIT - DN100 CONDUIT

#### WATER NOTES

- ALL WORKS CONSTRUCTED IN ACCORDANCE WITH RELEVANT LATEST ISSUE COUNCIL STANDARD DRAWINGS AND PROJECT SPECIFICATION.
- 2. ALL WATER MAINS ARE LOCATED ON A 1.8m ±0.1m ALIGNMENT OFFSET FROM PROPERTY BOUNDARIES, UNI ESS NOTED OTHERWISE
- 3. ALL upvc mains are class pn16 series 2 compatible to as 1477 RUBBER RING JOINTED, WITH SOCKETED DICL FITTINGS UNLESS NOTED
- 4. ALL 630D MAINS POLYETHYLENE CLASS PN16 TO AS 4130.
- 5. ALL TRENCHES UNDER ROAD PAVEMENT (INCLUDING FUTURE) BACKFILLED WITH CRUSHER DUST TO SUBGRADE LEVEL.
- 6. CONNECTION TO EXISTING WATER MAINS CARRIED OUT BY COUNCIL AT THE CONTRACTORS EXPENSE..

## SEWER LEGEND

MH.6.57\*

ML04f

IL=5.160\* TYPE D

STORMWATER DRAINAGE LINE SEWER MAIN AND MANHOLE (MH)

DN100 SEWER HOUSE DRAIN

EXISTING SEWER MAIN AND MANHOLE CERTIFIED TYPE & INDICATIVE TOP OF

MANHOLE LEVEL MANHOLE NUMBER LINE NUMBER

HOUSE CONNECTION (X&Y DIMENSIONS AS PER RELEVANT COUNCIL STANDARD DRAWING II NO )

SEWER MAIN AND MAINTENANCE SHAFT (MS)

CERTIFIED DISTANCE FROM DOWNSTREAM MANHOLE
CERTIFIED INVERT LEVEL OF HOUSE CONNECTION POINT HOUSE CONNECTION TYPE
TYPE A - ACROSS BOUNDARY 'SLOPE DROP' TYPE B -

ACROSS BOUNDARY JUMP UP'
TYPE C - WITHIN LOT 'DIRECT CONNECTION' TYPE D -

WITHIN LOT 'JUMP UP'
TYPE E - MANHOLE 'DIRECT CONNECTION' TYPE F -

MANHOLE 'INTERNAL DROP TYPE G - MAINTENANCE SHAFT CONNECTION TYPE Ex. **EXISTING HOUSE CONNECTION** 

#### **SEWER NOTES**

- 1. ALL WORKS CONSTRUCTED IN ACCORDANCE WITH RELEVANT LATEST ISSUE COUNCIL STANDARD DRAWINGS AND PROJECT SPECIFICATION
  2. ALL SEWERAGE MAINS LOCATED ON 1.5m ±0.1m ALIGNMENT OFFSET FROM
- THE PROPERTY BOUNDARIES, UNLESS NOTED OTHERWISE.

  3. ALL SEWERAGE MAINS DN150, UNLESS NOTED OTHERWISE.
- 4. ALL DN150 AND DN225 SEWERAGE MAINS uPVC DWV SN8, UNLESS NOTED OTHERWISE.
- 5. ALL DN100 HOUSE DRAINS uPVC DWV SN10, UNLESS NOTED OTHERWISE. (MAXIMUM | FNGTH 10.0m)
- 6. ALL TRENCHES UNDER ROAD PAVEMENT (INCLUDING FUTURE) BACKFILLED
- WITH CRUSHER DUST TO SUBGRADE LEVEL.
  7. CONNECTION/ALTERATIONS TO EXISTING SEWERAGE INFRASTRUCTURE
- CARRIED OUT BY COUNCIL AT THE CONTRACTORS EXPENSE
- . ALL MANHOLE INTERNAL DROP 'CORES' ARE NOT LOCATED WITHIN 150mm OF PRECAST WALL IDINTS.
- 9. TOP OF MANHOLE LEVELS PROVIDED ARE INDICATIVE, REFER TCC
- STANDARD DRAWING SD-475 FOR FINISHED LEVELS OF MANHOLE COVERS.



				Level Datum: AHD (DERIVED)		
No.	Date	Details	Check	B.M. Used: PSM193061 RL.11.206		
Α	08.06.22	Original Issue	GEO	Coordinate Projection: Plane		
				Coordinate Datum: Arbitrary		
				Origin of Coordinates: PSM193061	E:	
				Meridian: MGA (Zone 55)	N:	
				Map Reference: 8259-31131		
				Contour Interval:	Surveyed by:	B!
				Job No: 26700-228-01	Drawn: MJM	
				File No: 26700 235A.dwg	Approved:	

BRAZIER MOTTI PTY LTD (ACN 066 411 041), 595 Flinders Street, Townsville hereby certify that this Drawing accurately and correctly describes and records the nature and location of the works depicted by

TOWNSVILLE EARTHMOVING DO HEREBY CERTIFY THAT THE WORKS SHOWN ON THE 'AS CONSTRUCTED' DRAWINGS HAVE BEEN CONSTRUCTED IN ACCORDANCE WITH THE DRAWINGS AND CONTRACT DOCUMENTS APPROVED BY COUNCIL FOR THE CONSTRUCTION OF THE

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THE 13231 



AS CONSTRUCTED - GREATER ASCOT STAGE 801 & 802 GREATER ASCOT AVENUE - SHAW WATER AND SEWERAGE RETICULATION PLAN

Local Authority: Townsville City Counc

Plan No:

Date: 8th June, 2022

Scale: AS SHOWN

Sheet 1 of 1

26700/235 A

