


DESIGN CODE - ALL ALLOTMENTS

Туре	House, Front Loaded
Lot Access	Front
Lot Depth (Min)	25m (20m where 15m width proposed)
Lot Width (Min)	12.5
Site Coverage	May exceed 50% in response to Code Requirements, but no more than 60% Site Coverage.
Setback Front Ground (min) and upper (min)	3.5m
Setback Front Garage	6m and 1.5m behind front of dwelling
Setback Principal Side Ground (min)	QDC
Setback Principal Side Upper (min)	QDC
Setback Secondary Road Frontage (min)	2.0m
Garage setback Secondary Road Frontage(min)	3.5m
Setback Principal Rear (min)	1.5m (*Sewer lines and manholes may enforce greater setbacks)
Outbuilding (Shed) Width (max)	Lesser of 50% of rear boundary or 9m
Outbuilding (Shed) Depth (max)	9m
Outbuilding (Shed) Rear Setback	0-1.0m
Outbuilding (Shed) Side Setback	Zero if lot 12.5m wide. As per Principal setback if lot >12.5m wide
Floor Height Principal (min)	400mm
Maximum Storeys	As per the Applicable Scheme
Private Open Space (min) (may be covered)	4mx4m
Parking (min)	Two (2), one of which must be covered

*Note: Clearances to sewer lines and manholes are required in accordance with council policy.

- The final intended use of all allotments is for residential except if otherwise marked purposes in accordance with Cosgrove Plan of Development
- There are no buildings or structures over the land relevant to this stage
- Access into each allotment shall be via the road frontage. Specific locations to be determined at time of detailed engineering design and preparation of access envelopes.

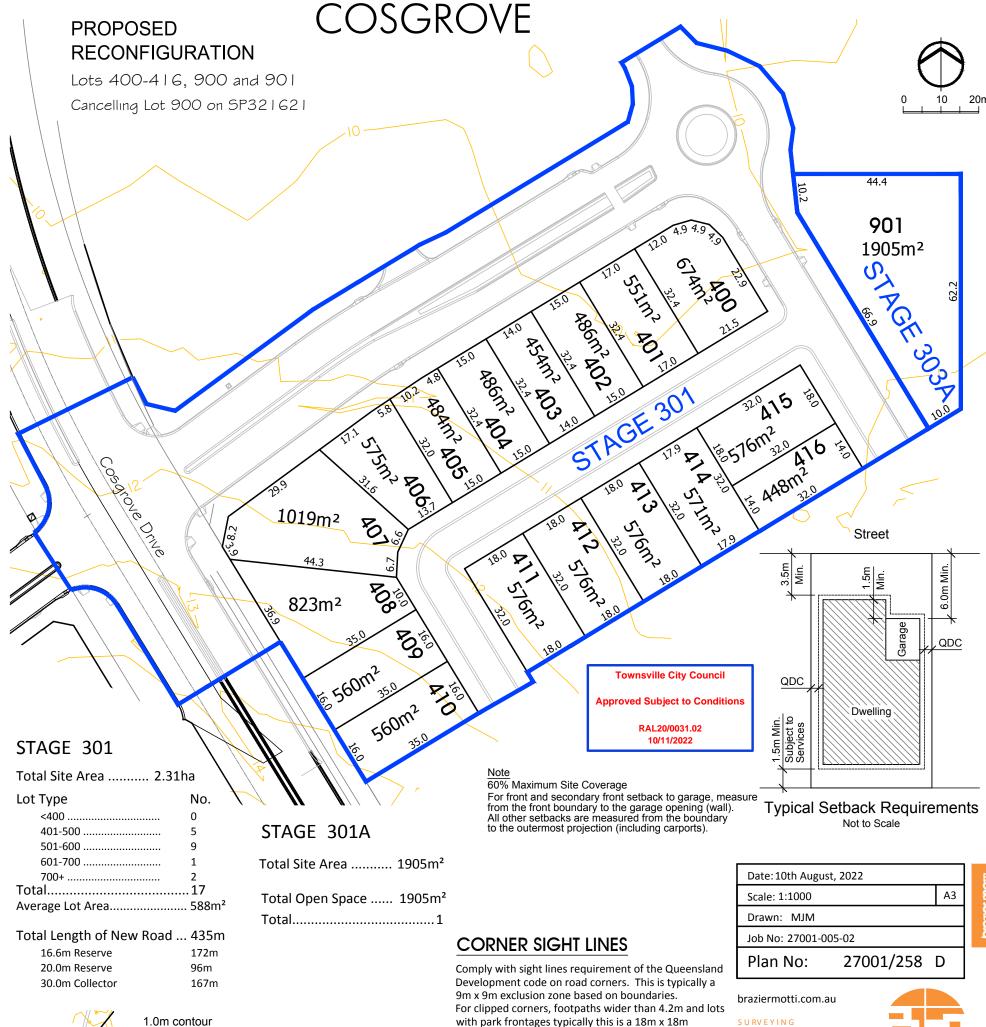

exclusion zone based on edge of traffic lane.

Rear access lanes are exempted from this requirement.


Stage Boundary

TOWNPLANNING


MAPPING&GIS


PROJECTMANAGEMENT

This plan is conceptual and for discussion purposes only. All areas, dimensions and land uses are preliminary, subject to investigation, survey, engineering, and Local Authority and Agency approvals.

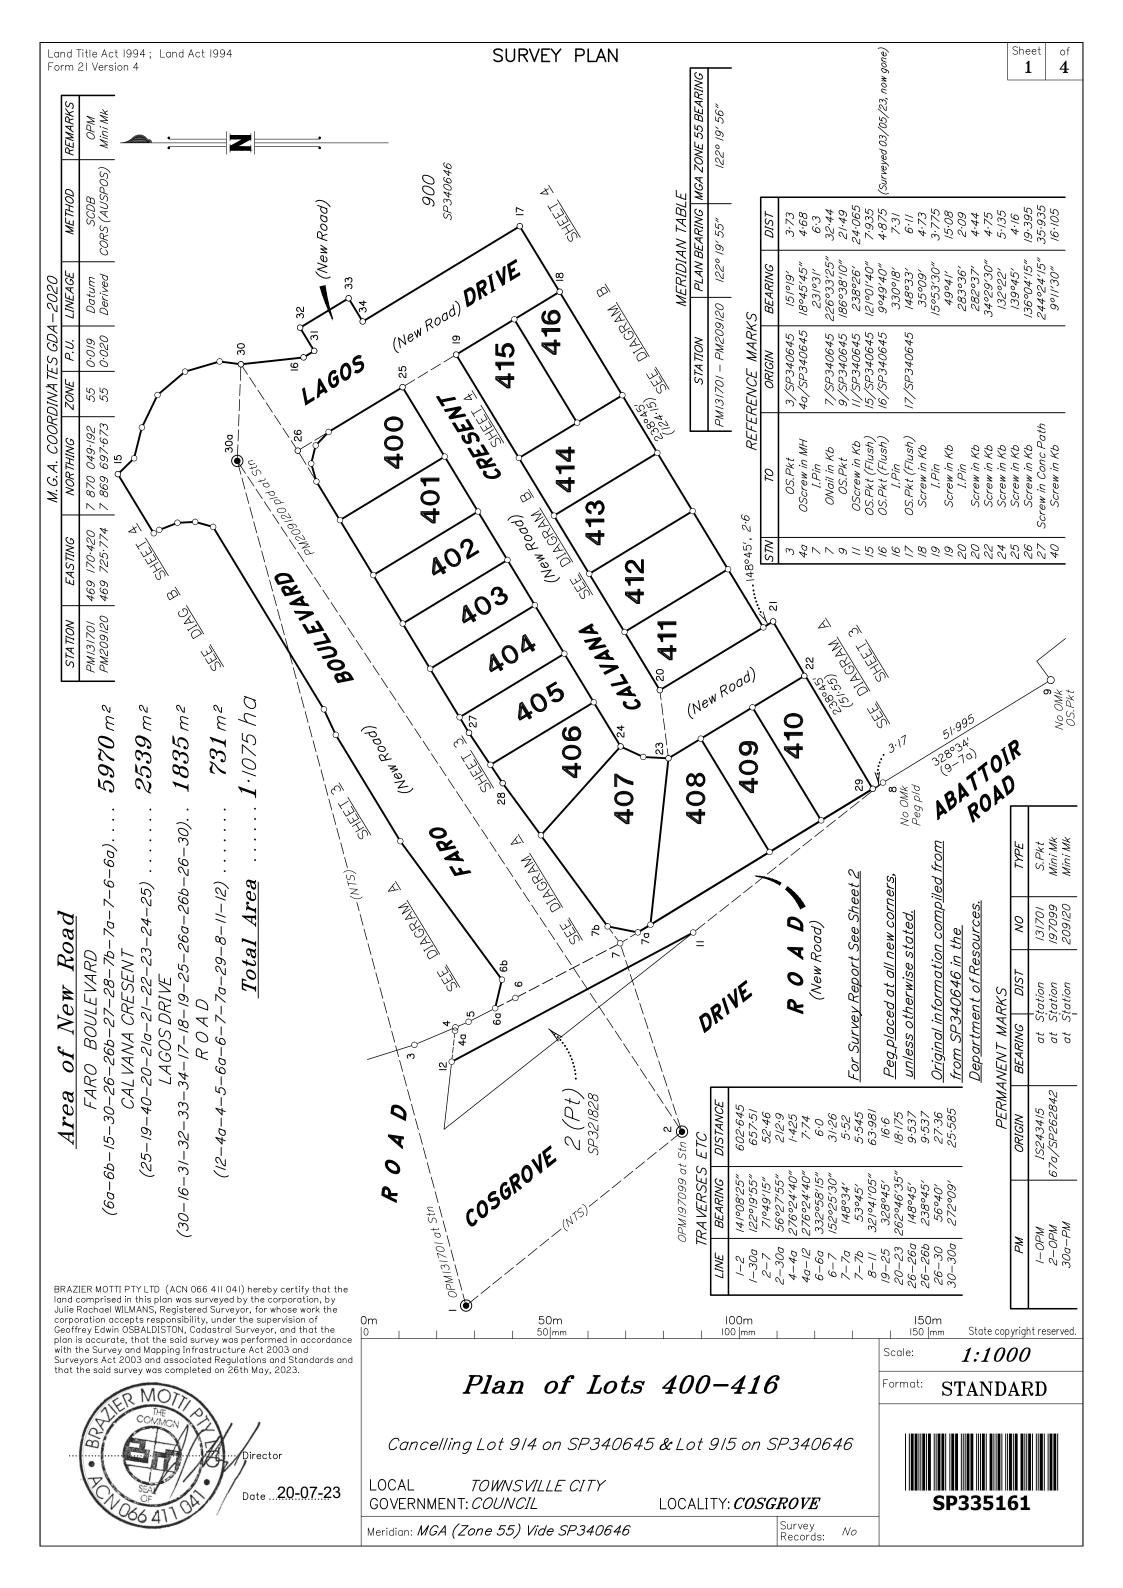


Land Title Act 1994; Land A Form 21B Version 2	ct 1994		WARNING: Folded or Mutilated Pla	
			Plans may be a Information may not be placed	
			4. Lodged by	C
	(Deali	ing No.)		
			(Include address, phone number, email, reference, ar	nd Lodger Code)
I.	Exis	sting	Cre	ated
Title Reference		Description	New Lots	Road Secondary Interests
51324140 51324139		Lot 915 on SP340646 Lot 914 on SP340645	400 – 416	New Rd
En	nt Z on SP262842	(Dealing 715892439) fully absorbed b	y new road	
SUR VEY REPO	OR T			
Datum	<u>, , , , , , , , , , , , , , , , , , , </u>			
	GA (Zone 55) vide	SP340646. This is confirmed by Meric	dian Table through	
	,	B Datum coordinates) and PM209120 (-	
Connection to	o datum is made b	y connections to PMI3I70I (SCDB) an	nd PM209120 (CORS).	
Boundary Re				
		-9 were reinstated from original corn	er and for reference marks	
		deed angles and distances.	ar unay or reference marks	
Boundaries 4	5-5-6-7-8 were i	reinstated using deed angles and dist	ances between Stns 4 & 8.	
Boundaries I.	5-16 were reinstat	ted from original corner and/or refere	ence marks found at Stns 15	
	ed angles and disto	- · · · · · · · · · · · · · · · · · · ·		
		e reinstated from the original referen	ce mark found at Stn 17, plus	
	and distances from			
Boundaries b	a-15 and 16-1/ w	ere compiled from SP340646.		6. Building Format Plans only.
				I certify that : * As far as it is practical to determine, no part
				of the building shown on this plan encroaches
				onto adjoining lots or road, * Part of the building shown on this plan
				encroaches onto adjoining * lots and road
				Cadastral Surveyor/Director* Date
				**delete words not required
		ı		7. Lodgement Fees :
				Survey Deposit \$
400-	-416	Lot 915 on SP340646		Lodgement \$
Lot		Orig		New Titles \$
2. Orig Grant Alloca	tion :		5. Passed & Endorsed :	Photocopy \$
3. References:			By: BRAZIER MOTTI PTY LTD	Postage \$
Dept File:			Date: 20-07-23	TOTAL \$
Local Govt :			Signed:	8. Insert Plan SP335161
Surveyor: 27001,	/177-01 - 27001_288	3A.dwg - SLR - 05/2023 - V 2	Designation : Liaison Officer	$\begin{array}{c} \text{Plan} \\ \text{Number} \end{array} \hspace{0.5cm} SP335161$

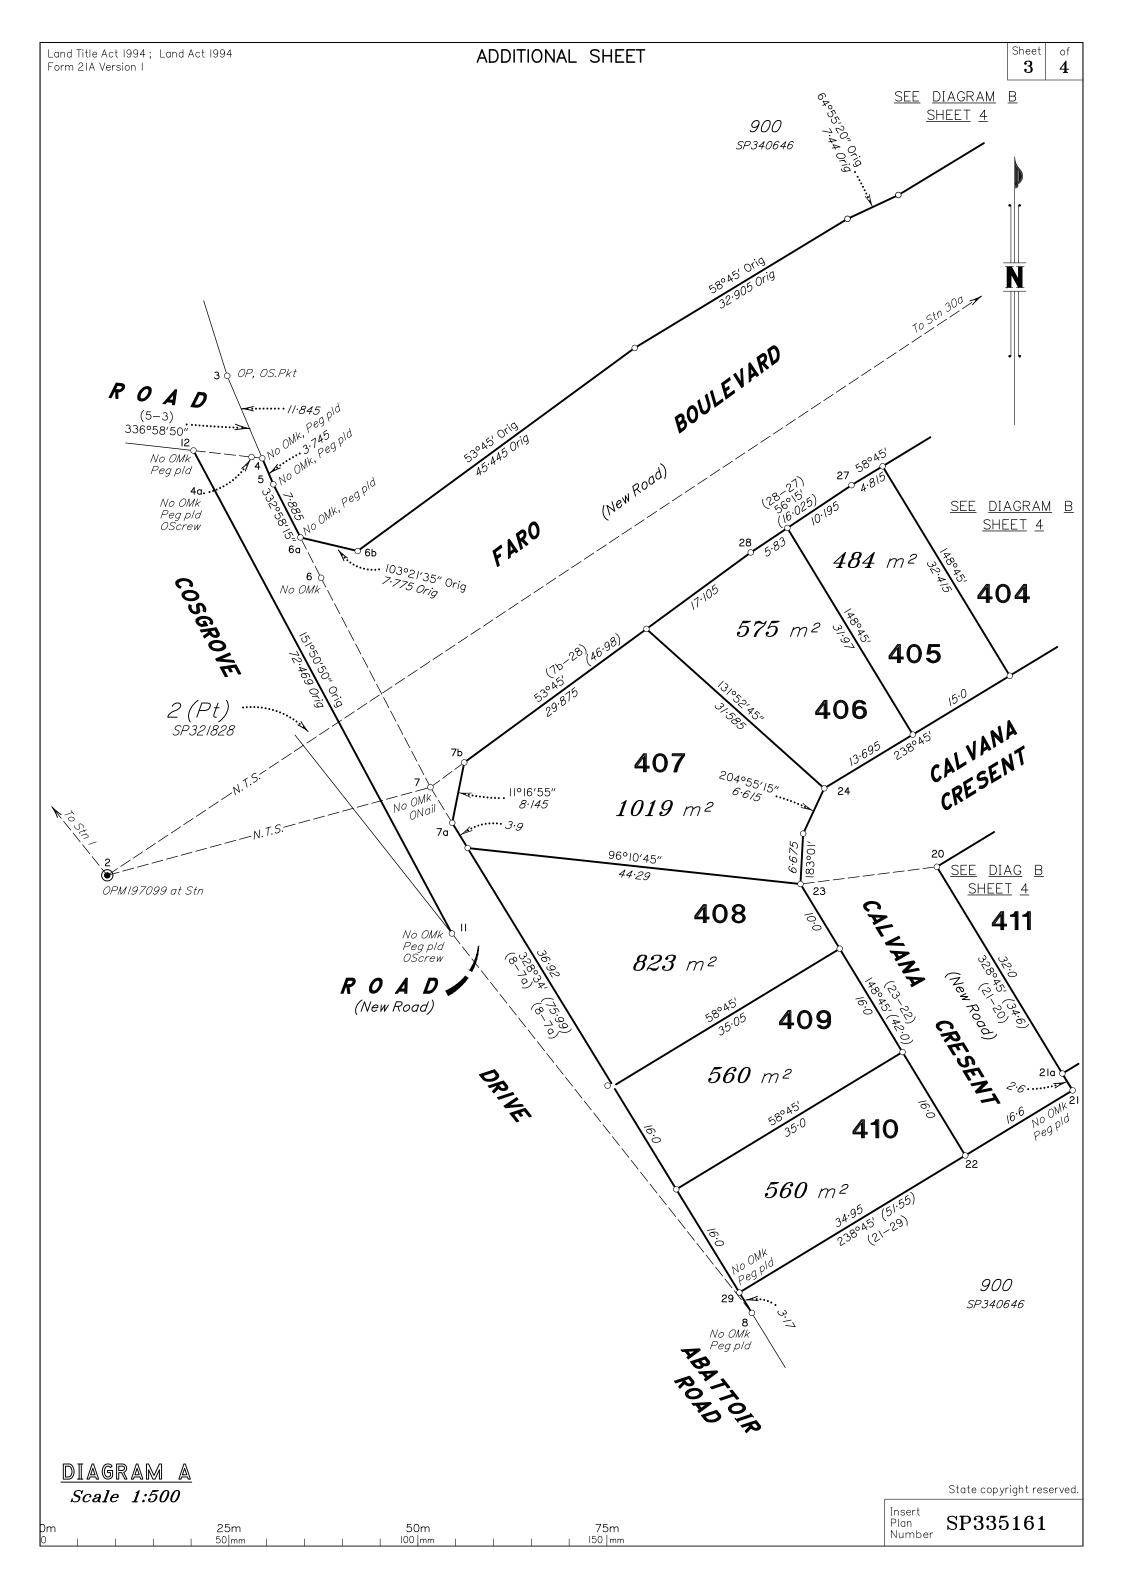

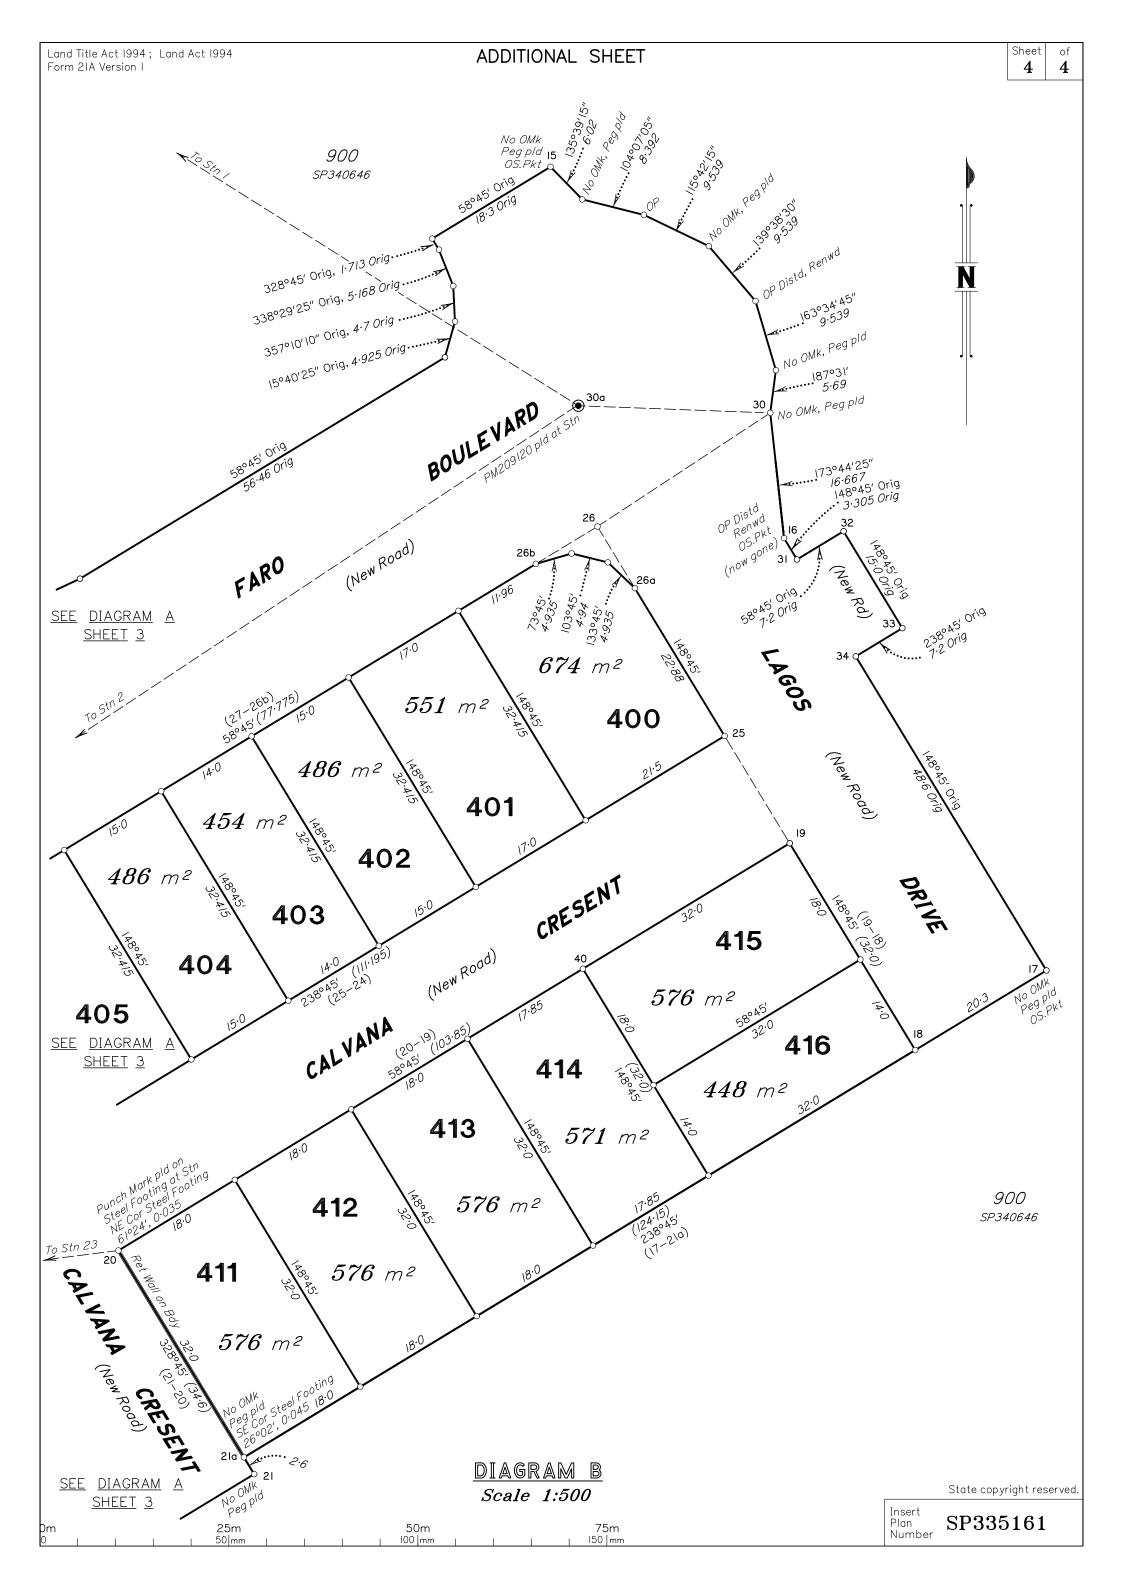

COSGROVE STAGES 301 & 302 COSGROVE DRIVE, COSGROVE FOR PARKSIDE DEVELOPMENT PTY LTD

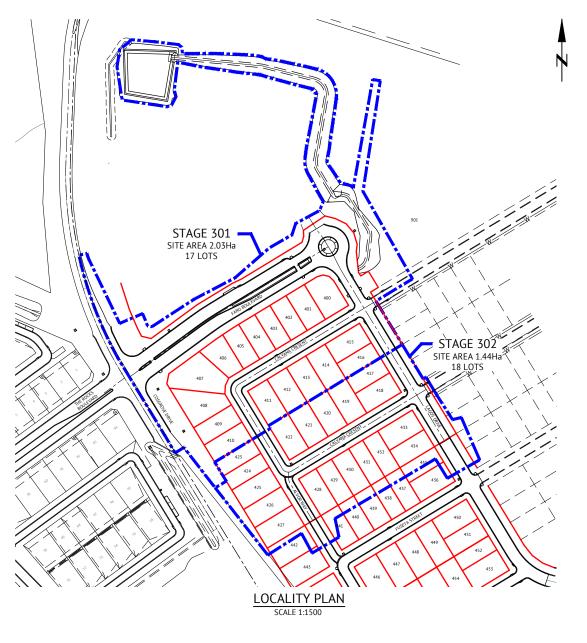

	DRAWING SCHEDULE
DRAWING NO.	DRAWING TITLE
266	COVER SHEET, LOCALITY PLAN & DRAWING SCHEDULE
267	EARTHWORKS LAYOUT PLAN
268	ROADWORKS & STORMWATER DRAINAGE PLAN
269	COSGROVE DRIVE LONGITUDINAL AND CROSS SECTIONS
270	FARO BOULEVARD LONGITUDINAL AND CROSS SECTIONS
271	LAGOS DRIVE LONGITUDINAL AND CROSS SECTIONS
272	CALVANA CRESCENT LONGITUDINAL AND CROSS SECTIONS
273	ALVOR WAY LONGITUDINAL AND CROSS SECTIONS
274	ROADWORKS DETAILS PLAN - SHEET 1 OF 2
275	ROADWORKS DETAILS PLAN - SHEET 2 OF 2
276	MISCELLANEOUS DETAILS PLAN
277	RETAINING WALL DETAILS
278	LINEMARKING DETAILS PLAN - SHEET 1 OF 3
279	LINEMARKING DETAILS PLAN - SHEET 2 OF 3
280	LINEMARKING DETAILS PLAN - SHEET 3 OF 3
281	Q2 STORMWATER LONGITUDINAL SECTION - SHEET 1 OF 3
282	Q2 STORMWATER LONGITUDINAL SECTION - SHEET 2 OF 3
283	Q2 STORMWATER LONGITUDINAL SECTION - SHEET 3 OF 3
284	WATER RETICULATION PLAN
285	SEWER RETICULATION PLAN
286	BIO-RETENTION DETAILS PLAN



Revisi				Level Datum: AHD (DERIVED)		
No.	Date	Details	Check	B.M. Used: PM127952 RL.9.066		
Α	16.06.23	Original Issue	GEO	Coordinate Projection: Plane		
				Coordinate Datum: Site		
				Origin of Coordinates: PM127952	E:	69522.193
				Meridian: MGA Zone 55	N:	91444.889
				Map Reference:		
				Contour Interval:	Sur	veyed by: BM
				Job No: 27001-178-01	Dra	wn: MJM
	1		1	File No. 27001 2664 dug	Ann	round

MENDI CONSTRUCTIONS DO HEREBY CERTIFY THAT THE WORKS SHOWN ON THE 'AS CONSTRUCTEO' DRAWINGS HAVE BEEN CONSTRUCTEO IN ACCORDANCE WITH THE DRAWINGS AND CONTRACT DOCUMENTS APPROVED BY COUNCIL FOR THE CONSTRUCTION OF THE PROJECT.

PREMISE DO HEREBY CERTIFY THAT THE WORKS AS SHOWN ON THE 'AS CONSTRUCTED' DRAWINGS REFLECT ANY CHANGES THAT WERE MADE DURING THE COURSE OF CONSTRUCTION.




PARKSIDE DEVELOPMENT PTY LTD
Project:
AS CONSTRUCTED - COSGROVE 301 & 302
COSGROVE DRIVE, COSGROVE
COVER SHEET, LOCALITY PLAN & DRAWING SCHEDULE


ocal Authority: Townsville City Council


Date: 16th June	e, 2023			
Sheet 1	of	1	Sheets	5
Scale: AS SHOV	VN			A1
Plan No:	270	01/	266	Α





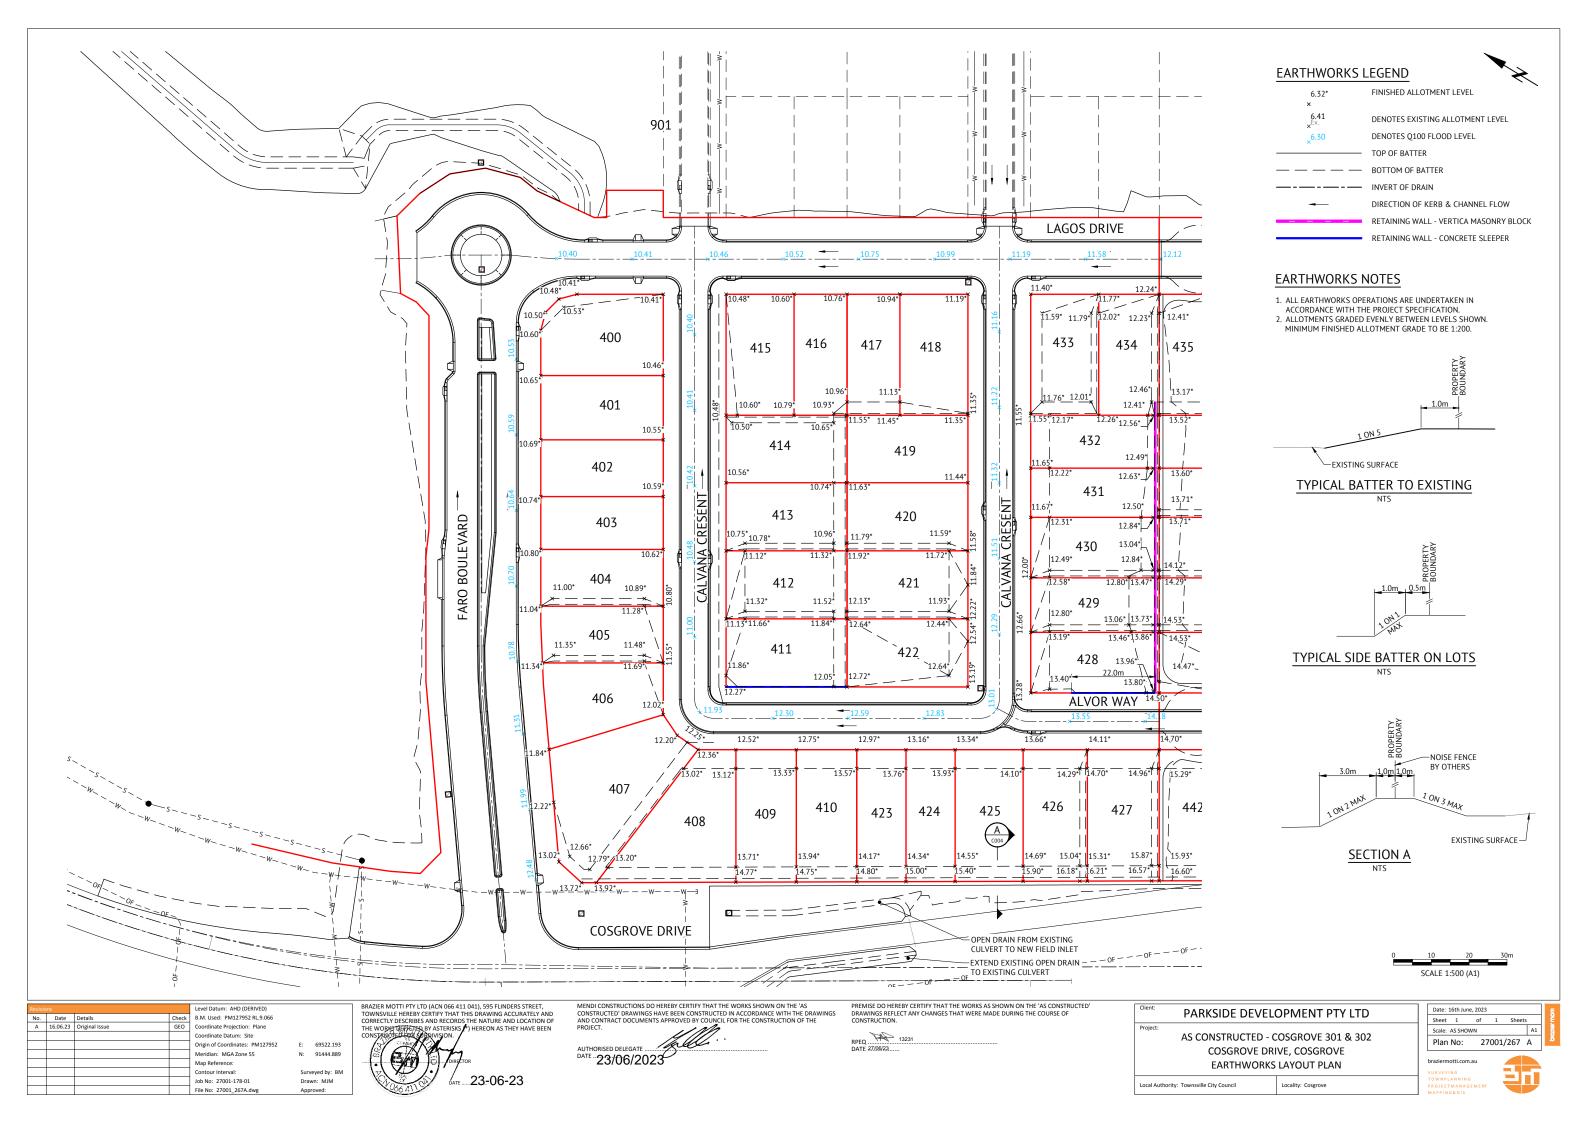


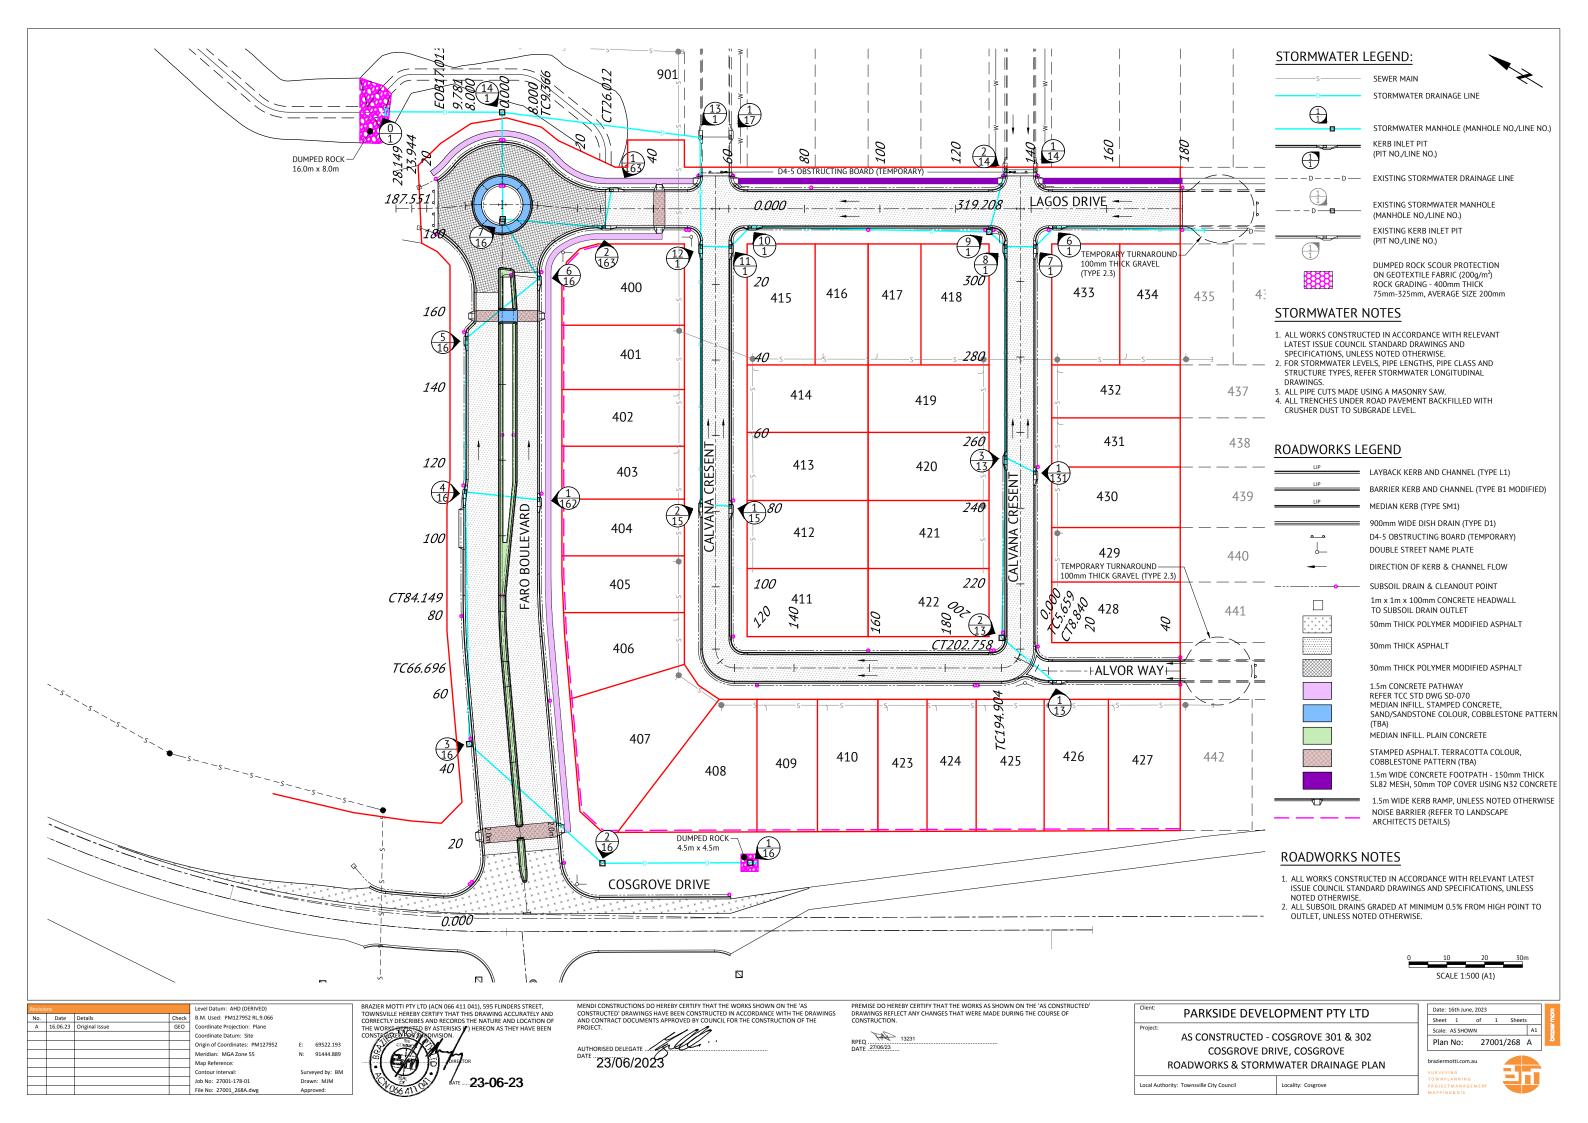


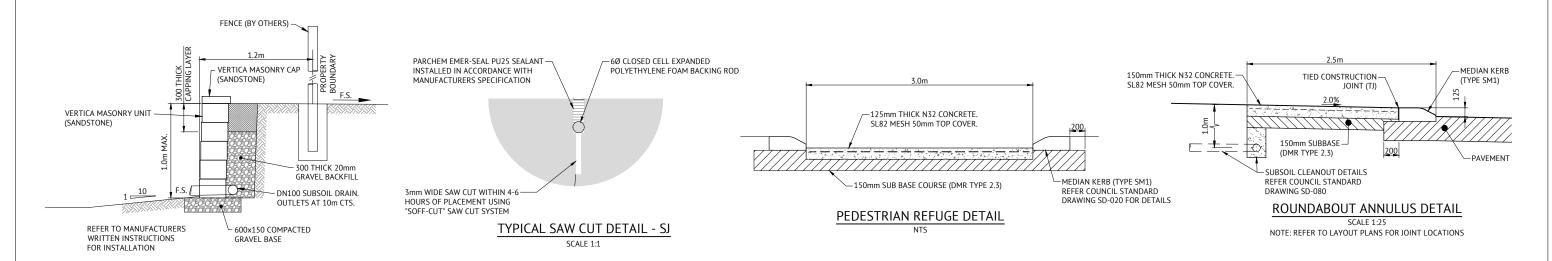


TYPICAL RETAINING WALL DETAIL (VIRTICA MASONRY BLOCK)

SCALE 1:20

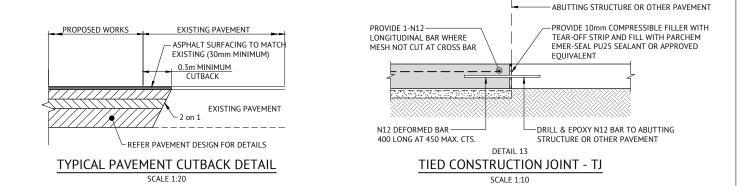

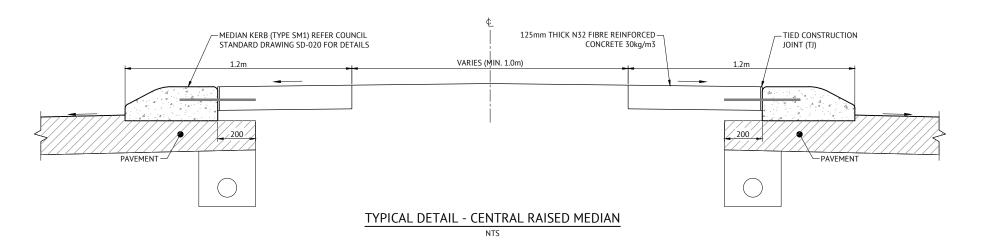

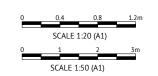

				Level Datum: AHD (DERIVED)		
No.	Date	Details	Check	B.M. Used: PM127952 RL.9.066		
Α	16.06.23	Original Issue	GEO	Coordinate Projection: Plane		
				Coordinate Datum: Site		
				Origin of Coordinates: PM127952	E:	69522.193
				Meridian: MGA Zone 55	N:	91444.889
				Map Reference:		
				Contour Interval:	Sur	veyed by: BM
				Job No: 27001-178-01	Dra	wn: MJM
				File No: 27001 276A.dwg	App	roved:

MENDI CONSTRUCTIONS DO HEREBY CERTIFY THAT THE WORKS SHOWN ON THE "AS CONSTRUCTED' DRAWINGS HAVE BEEN CONSTRUCTED IN ACCORDANCE WITH THE DRAWINGS AND CONTRACT DOCUMENTS APPROVED BY COUNCIL FOR THE CONSTRUCTION OF THE PROJECT.

AUTHORISED DELEGATE

DATE ... 23/06/2023

PREMISE DO HEREBY CERTIFY THAT THE WORKS AS SHOWN ON THE 'AS CONSTRUCTED' DRAWINGS REFLECT ANY CHANGES THAT WERE MADE DURING THE COURSE OF CONSTRUCTION.




Client:	PARKSIDE DEVELO	OPMENT PTY LTD
Project:	AS CONSTRUCTED - C COSGROVE DRI MISCELLANEOU	VE, COSGROVE
Local Authority: Townsville City Council		Locality: Cosgrove







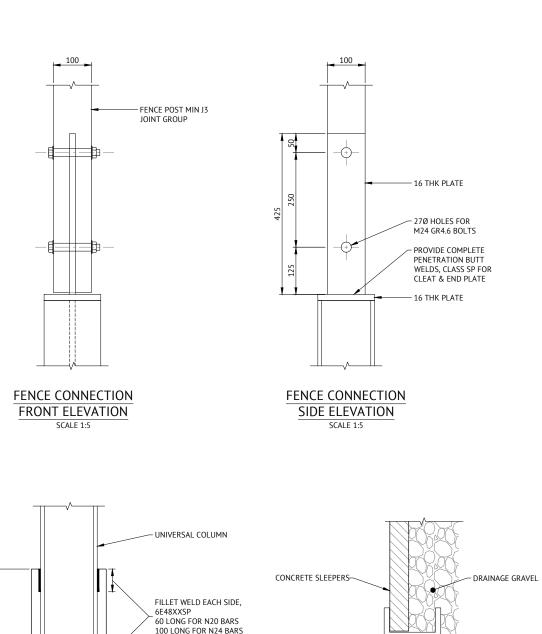


UNIVERSAL COLUMN -

SECTION A

SCALE 1:5

FRONT/REAR REINFORCING

R10-300 TIES (AS SPECIFIED)

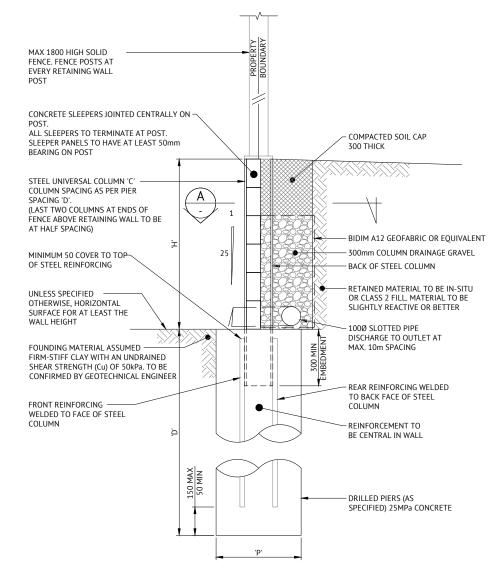

TYPICAL SLEEPER WALL SECTION SCALE 1:10

WALL NOTES:

12

- STEEL COLUMNS TO BE MINIMUM GRADE 300t AND HOT DIPPED GALVANISED, HDG500 AS PER AS4680.
- CONCRETE SLEEPERS ARE TO CONCRIB SPECIFICATIONS.
- THE WALL IS DESIGNED FOR A MAXIMUM BACKSLOPE ABOVE THE WALL OF 1 IN 10
- CONSTRUCTION TRAFFIC MUST BE KEPT A DISTANCE EQUIVALENT TO THE WALL HEIGHT AWAY FROM THE BACK OF THE WALL.
- LARGE TREES AND SHRUBS ARE NOT TO BE PLANTED CLOSE TO THE
- WATERING OF GARDEN BEDS AT THE TOP OF THE WALL MUST BE KEPT TO A MINIMUM.


 THE WALL SHOULD HAVE A BACK LEAN OF APPROXIMATELY 1 IN 25.
- BACKFILLING SHOULD NOT TAKE PLACE UNTIL THE CONCRETE HAS CURED FOR AT LEAST 3 DAYS.
- NO EXCAVATION TO TAKE PLACE WITHIN 1m OF THE FRONT OF THE
- THIS WALL IS NOT SUITABLE FOR AREAS SUBJECT TO FLOODING.
- 11. MINIMUM ALLOWABLE BEARING CAPACITY FOR FOUNDING SOILS IS 100kPa
 - THE WALL HAS BEEN DESIGNED FOR 5kPa LIVE LOAD.
- THE WALL HAS A DESIGN LIFE OF 60 YEARS AS PER AS4678. 13.
- THE WALL HAS BEEN DESIGNED BASED ON RETAINED MATERIAL HAVING AN INTERNAL FRICTION ANGLE OF 28°. GEOTECHNICAL ENGINEER TO CONFIRM.
- DESIGN IS BASED ON A C2 WIND CLASSIFICATION.
- WALL IS DESIGNED FOR DRAINED CONDITIONS. GEOTECHNICAL ENGINEER TO CONFIRM.
- FOOTINGS HAVE BEEN DESIGNED BASED ON A FIRM-STIFF CLAY 17. WITH AN UNDRAINED COHESION OF 50kPa. GEOTECHNICAL ENGINEER TO CONFIRM.
- BOTTOM & MIDDLE FENCE RAILS TO BE INSTALLED AT COMPLETION OF POST INSTALLATION FOR SAFETY. GEOTECHNICAL ENGINEER TO CONFIRM SOIL IS NON-AGGRESSIVE.

IF CONDITIONS ON SITE VARY FROM THE ABOVE, CONTACT PREMISE IMMEDIATELY.

'CONCRIB' OR APPROVED **EOUIVALENT CONCRETE** SLEEPER WALL TO MANUFACTURER'S **SPECIFICATION**

WALL DETAILS

WALL HEIGHT 'H'	FRONT FACE REINFORCMENT	REAR FACE REINFORCEMENT	TIES	COLUMN SIZE 'C'	PIER FOOTING SIZE 'P'	PIER FOOTING SIZE 'D'
≤ 1000	2 x N20	3 x N20	R10-300	150UC23.4	450Ø	1900 @ 2000 CTRS
≤ 1400	2 x N20	3 x N20	R10-300	150UC23.4	450Ø	2400 @ 2000 CTRS

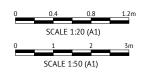

WELDING DETAILS

SCALE 1:5

Level Datum: AHD (DERIVED B.M. Used: PM127952 RL.9.066 16.06.23 Original Issue Coordinate Projection: Plane Coordinate Datum: Site Meridian: MGA Zone 55 91444.889 Surveyed by: BM Job No: 27001-178-01 File No: 27001_277A.dwg

MENDI CONSTRUCTIONS DO HEREBY CERTIFY THAT THE WORKS SHOWN ON THE 'AS MENDI CONSTRUCTIONS DO HEREBY CERTIFY THAT THE WORKS SHOWN ON THE CONSTRUCTED PRAWINGS HAVE BEEN CONSTRUCTED IN ACCORDANCE WITH THE DRAWINGS AND CONTRACT DOCUMENTS APPROVED BY COUNCIL FOR THE CONSTRUCTION OF THE PROJECT.

PREMISE DO HEREBY CERTIFY THAT THE WORKS AS SHOWN ON THE 'AS CONSTRUCTED' DRAWINGS REFLECT ANY CHANGES THAT WERE MADE DURING THE COURSE OF CONSTRUCTION.





nenc.	PARKSIDE DEVELOPMENT PTY LTD	
roject:		
	AS CONSTRUCTED - COSGROVE 301 & 302	
	COSGROVE DRIVE, COSGROVE	
	RETAINING WALL DETAILS	


Sheet 1 of 1 Sheets Scale: AS SHOWN 27001/277 A Plan No:




Local Authority: Townsville City Council Locality: Cosgrov

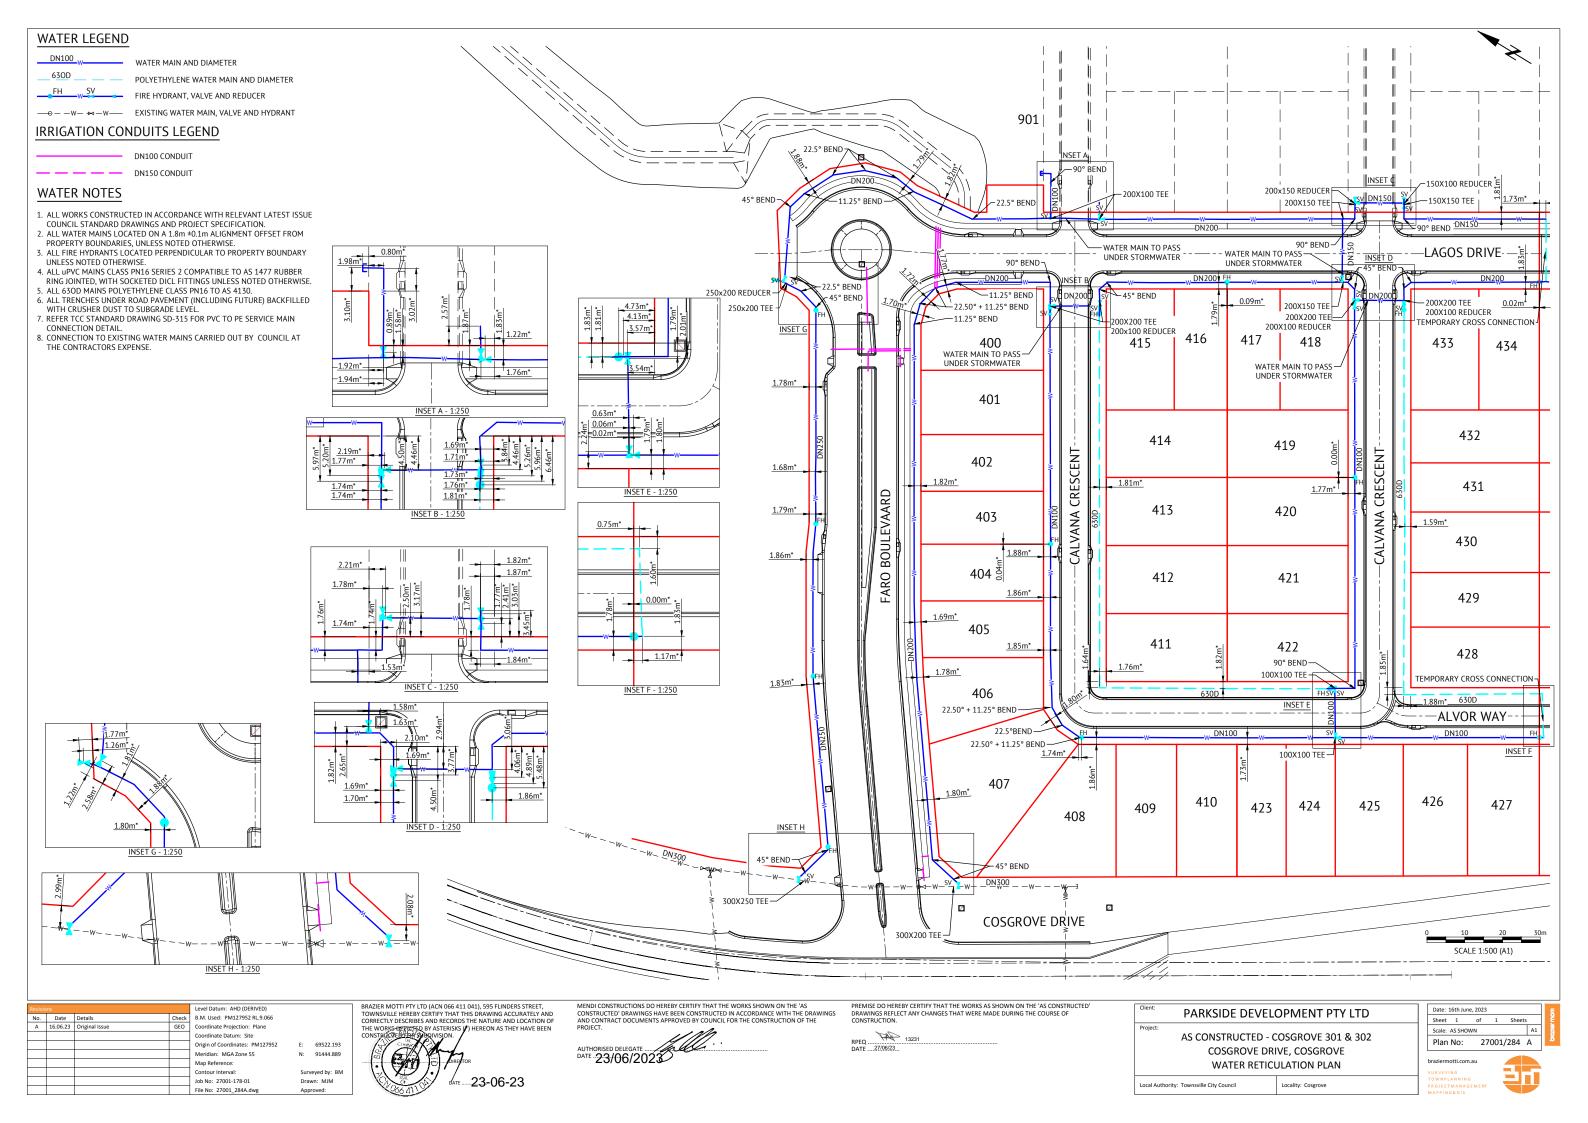

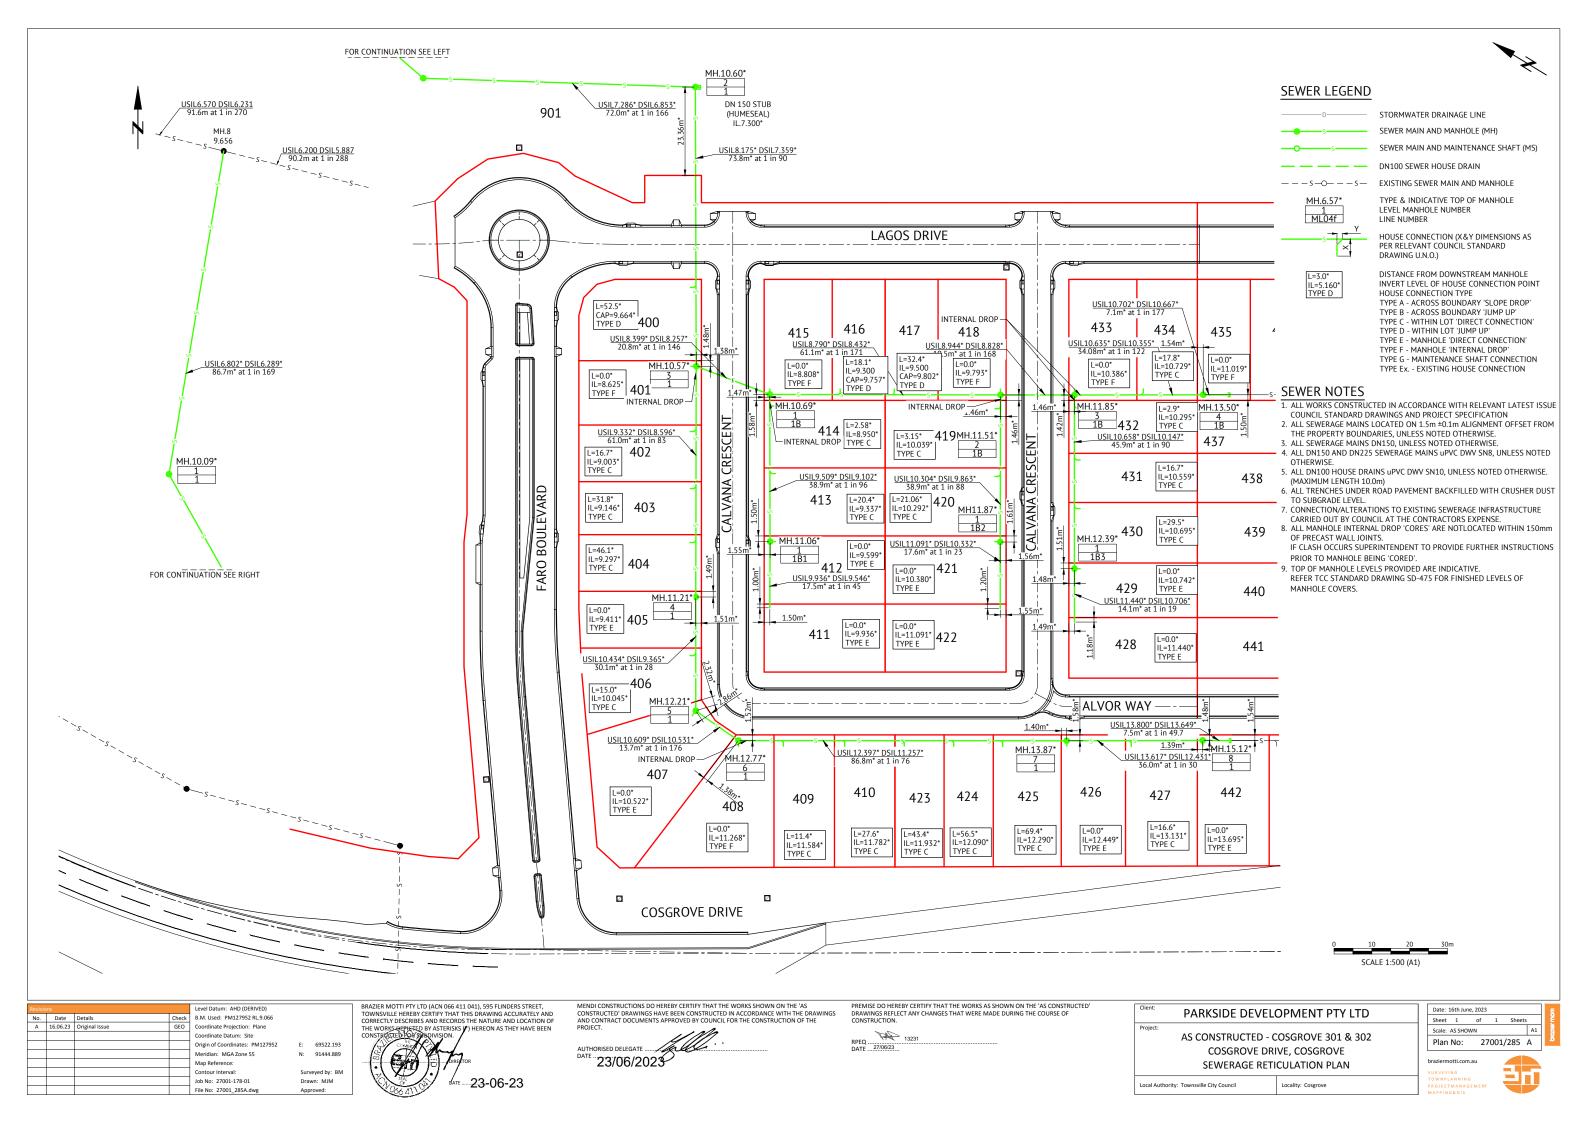

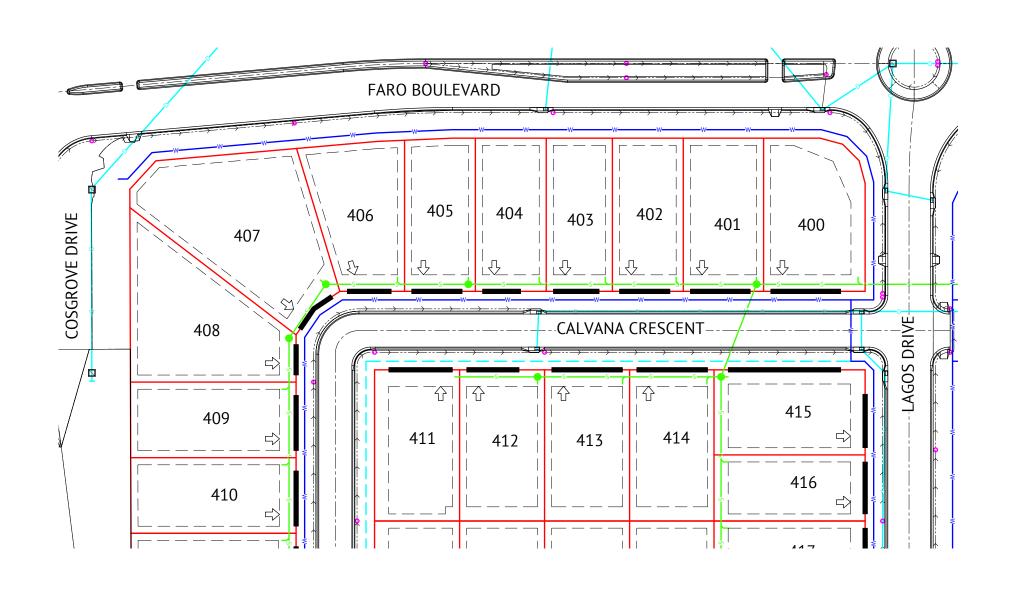

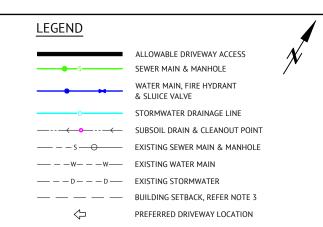

DRIVEWAY ACCESS ENVELOPE

- FOR DRIVEWAY ACCESS ENVELOPE ALLOW 0.5m MINIMUM CLEARANCE TO ALL COUNCIL INFRASTRUCTURE, EXCEPT STORMWATER PITS WHICH REQUIRED 0.6m MINIMUM CLEARANCE AND SEWERAGE HOUSE CONNECTIONS WHICH REQUIRE 1.2m MINIMUM CLEARANCE.
- 2. ALL DRIVEWAYS REQUIRED A PERMIT FROM COUNCIL PRIOR TO CONSTRUCTION

CORNER SIGHT LINES

- 1. COMPLY WITH SIGHT LINES REQUIREMENT OF THE QUEENSLAND AND DEVELOPMENT CODE ON ROAD CORNERS. THIS IS TYPICALLY A 9m x 9m EXCLUSION ZONE BASED ON BOUNDARIES.
- FOR CLOPPED CORNERS AND LOTS WITH PARK FRONT AGES TYPICALLY THIS IS A 18m x 18m EXCLUSION ZONE BASED ON THE EDGE OF THE TRAFFIC LANE. REAR ACCESS LANES ARE EXEMPTED FROM THIS REQUIREMENT.


BUILDING SETBACK

- "SETBACK" MEANS A LINE OR LINES PARALLEL TO ANY BOUNDARY OF A LOT BEYOND WHICH THE BUILDING OR OTHER STRUCTURE SHALL NOT ENCROACH, AND MEASURED AS THE SHORTEST HORIZONTAL DISTANCE FROM THE OUTERMOST PROJECTION OF THE BUILDING OR OTHER STRUCTURE TO THE VERTICAL PROJECTION OF THE LOT BOUNDARY (TOWNSVILLE CITY PLAN 2005, PAGE 491).
- 2. THE BUILDING ENVELOPES ARE TO COMPLY WITH THE DESIGN CODE SHOWN ON THIS PLAN, GREATER SETBACKS MAY BE REQUIRED TO ACCOMMODATE THE ZONE OF INFLUENCE OF UNDERGROUND SERVICES AS STATED IN COUNCIL'S POLICY ON BUILDING OVER OR ADJACENT TO SEWERS.
- DIMENSIONS ARE QDC GROUND DWELLING ONLY AND DO NOT ACCOUNT FOR BATTERS OR RETAINING WALLS. A SITE INSPECTION IS REQUIRED PRIOR TO COMMENCEMENT OF DESIGN. REFER DESIGN CODE FOR UPPER FLOOR AND GARAGE SETBACKS.

DESIGN CODE - ALL ALLOTMENTS

TYPE	HOUSE, FRONT LOADED
LOT ACCESS	FRONT
LOT DEPTH (MIN)	25m (20m WHERE 15m WIDTH PROPOSED)
LOT WIDTH (MIN)	10.0m
SITE COVERAGE	MAY EXCEED 50% IN RESPONSE TO CODE REQUIREMENT BUT NO MORE THAN 60% SITE COVERAGE.
SETBACK FRONT GROUND (MIN) AND UPPER (MIN)	3.5m
SETBACK FRONT GARAGE	6m AND 1.5m BEHIND FRONT OF DWELLING
SETBACK PRINCIPAL SIDE GROUND (MIN)	QDC
SETBACK PRINCIPAL SIDE UPPER (MIN)	QDC
SETBACK SECONDARY ROAD FRONTAGE (MIN)	2m
SETBACK PRINCIPAL REAR (MIN)	1.5m (SEWER LINES AND MANHOLES MAY ENFORCE GREATER SETBACKS)*
OUTBUILDING (SHED) WIDTH (MAX)	LESSER OF 50% OF REAR BOUNDARY OR 9m
OUTBUILDING (SHED) DEPTH (MAX)	9m
OUTBUILDING (SHED) REAR SETBACK	0-1.0m
OUTBUILDING (SHED) SIDE SETBACK	ZERO IF LOT 12.5m WIDE. AS PER PRINCIPAL SETBACK IF LOT >12.5m WIDE
FLOOR HEIGHT PRINCIPAL (MIN)	400mm
MAXIMUM STOREYS	AS PER THE APPLICABLE SCHEME
PRIVATE OPEN SPACE (MIN) (MAY BE COVERED)	4mx4m
PARKING (MIN)	TWO (2), ONE OF WHICH MUST BE COVERED

*NOTE: CLEARANCES TO SEWER LINES AND MANHOLES ARE REQUIRED IN ACCORDANCE WITH COUNCIL POLICY.

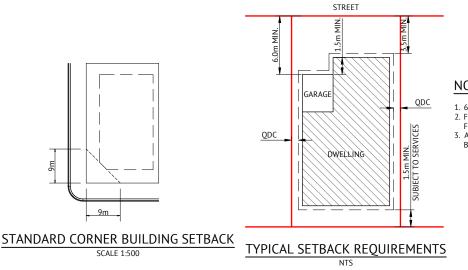


NOTES 1. 60% MAXIMUM SITE COVERAGE. 2. FOR FRONT SETBACK TO GARAGE, MEASURE FROM THE FRONT BOUNDARY TO THE GARAGE OPENING (WALL). 3. ALL OTHER SETBACKS ARE MEASURED FROM THE BOUNDARY TO THE OUTERMOST PROJECTIONS.

LIGHT POLES & TELSTRA PITS HAVE NOT BEEN SHOWN





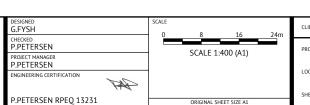



.IENT	PARKSIDE DEVELOPMENT PTY LTD
ROJECT	COSGROVE STAGE 301 & 302
OCATION	COSGROVE DRIVE, COSGROVE
HEET TITLE	BUILDING ENVELOPE & DRIVEWAY ACCESS PLAN - SHEET 1 OF 2

PAR-0226

SHEET NUMBER REV

CO32

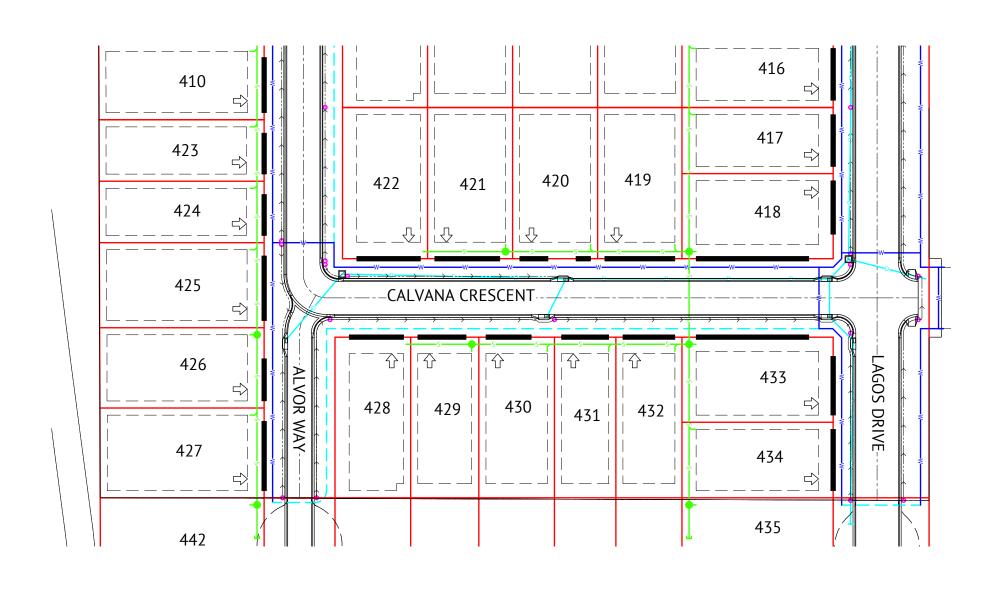

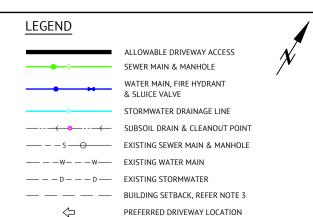

DRIVEWAY ACCESS ENVELOPE

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BUILDING SETBACK


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- PAGE 491).


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MAXIMUM STOREYS	AS PER THE APPLICABLE SCHEME
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*NOTE: CLEARANCES TO SEWER LINES AND MANHOLES ARE REQUIRED IN ACCORDANCE WITH COUNCIL POLICY.






HOUSE CONNECTION DETAIL NOTE: MINIMUM 1.0m CLEARANCE FROM END OF SEWER HOUSE

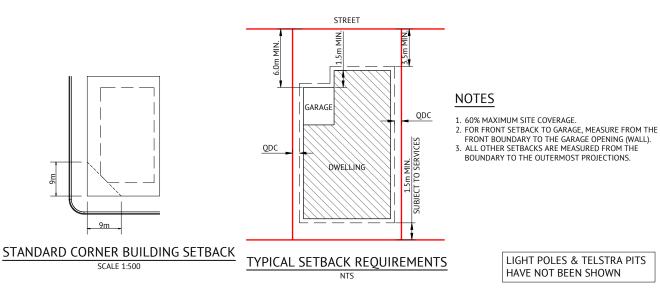NOTE: MINIMUM 1.0m CLEARANCE FROM END OF SEWER HOUSE CONNECTION TO THE NEAREST POINT OF THE STRUCTURE FOUNDATION OR 2.0m CLEARANCE FROM CONNECTION AT MAIN/CENTRE OF MANHOLE.

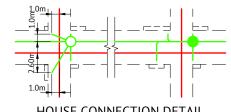CONSTRUCTION ISSUE					
30/09/2022	Α	ISSUED FOR CONSTRUCTION	L,H	P.P	
10/04/2022	1	PRELIMINARY - NOT FOR CONSTRUCTION	L,H	P.P	
DATE	RFV	DESCRIPTION	REC	APP	




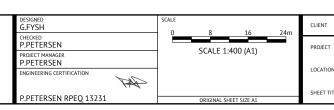


	PARKSIDE DEVELOPMENT PTY LTD
	COSGROVE STAGE 301 & 302
N	COSGROVE DRIVE, COSGROVE
TLE	BUILDING ENVELOPE & DRIVEWAY ACCESS PLAN - SHEET 2 OF 2

PAR-0226

SHEET NUMBER REV CO33 A

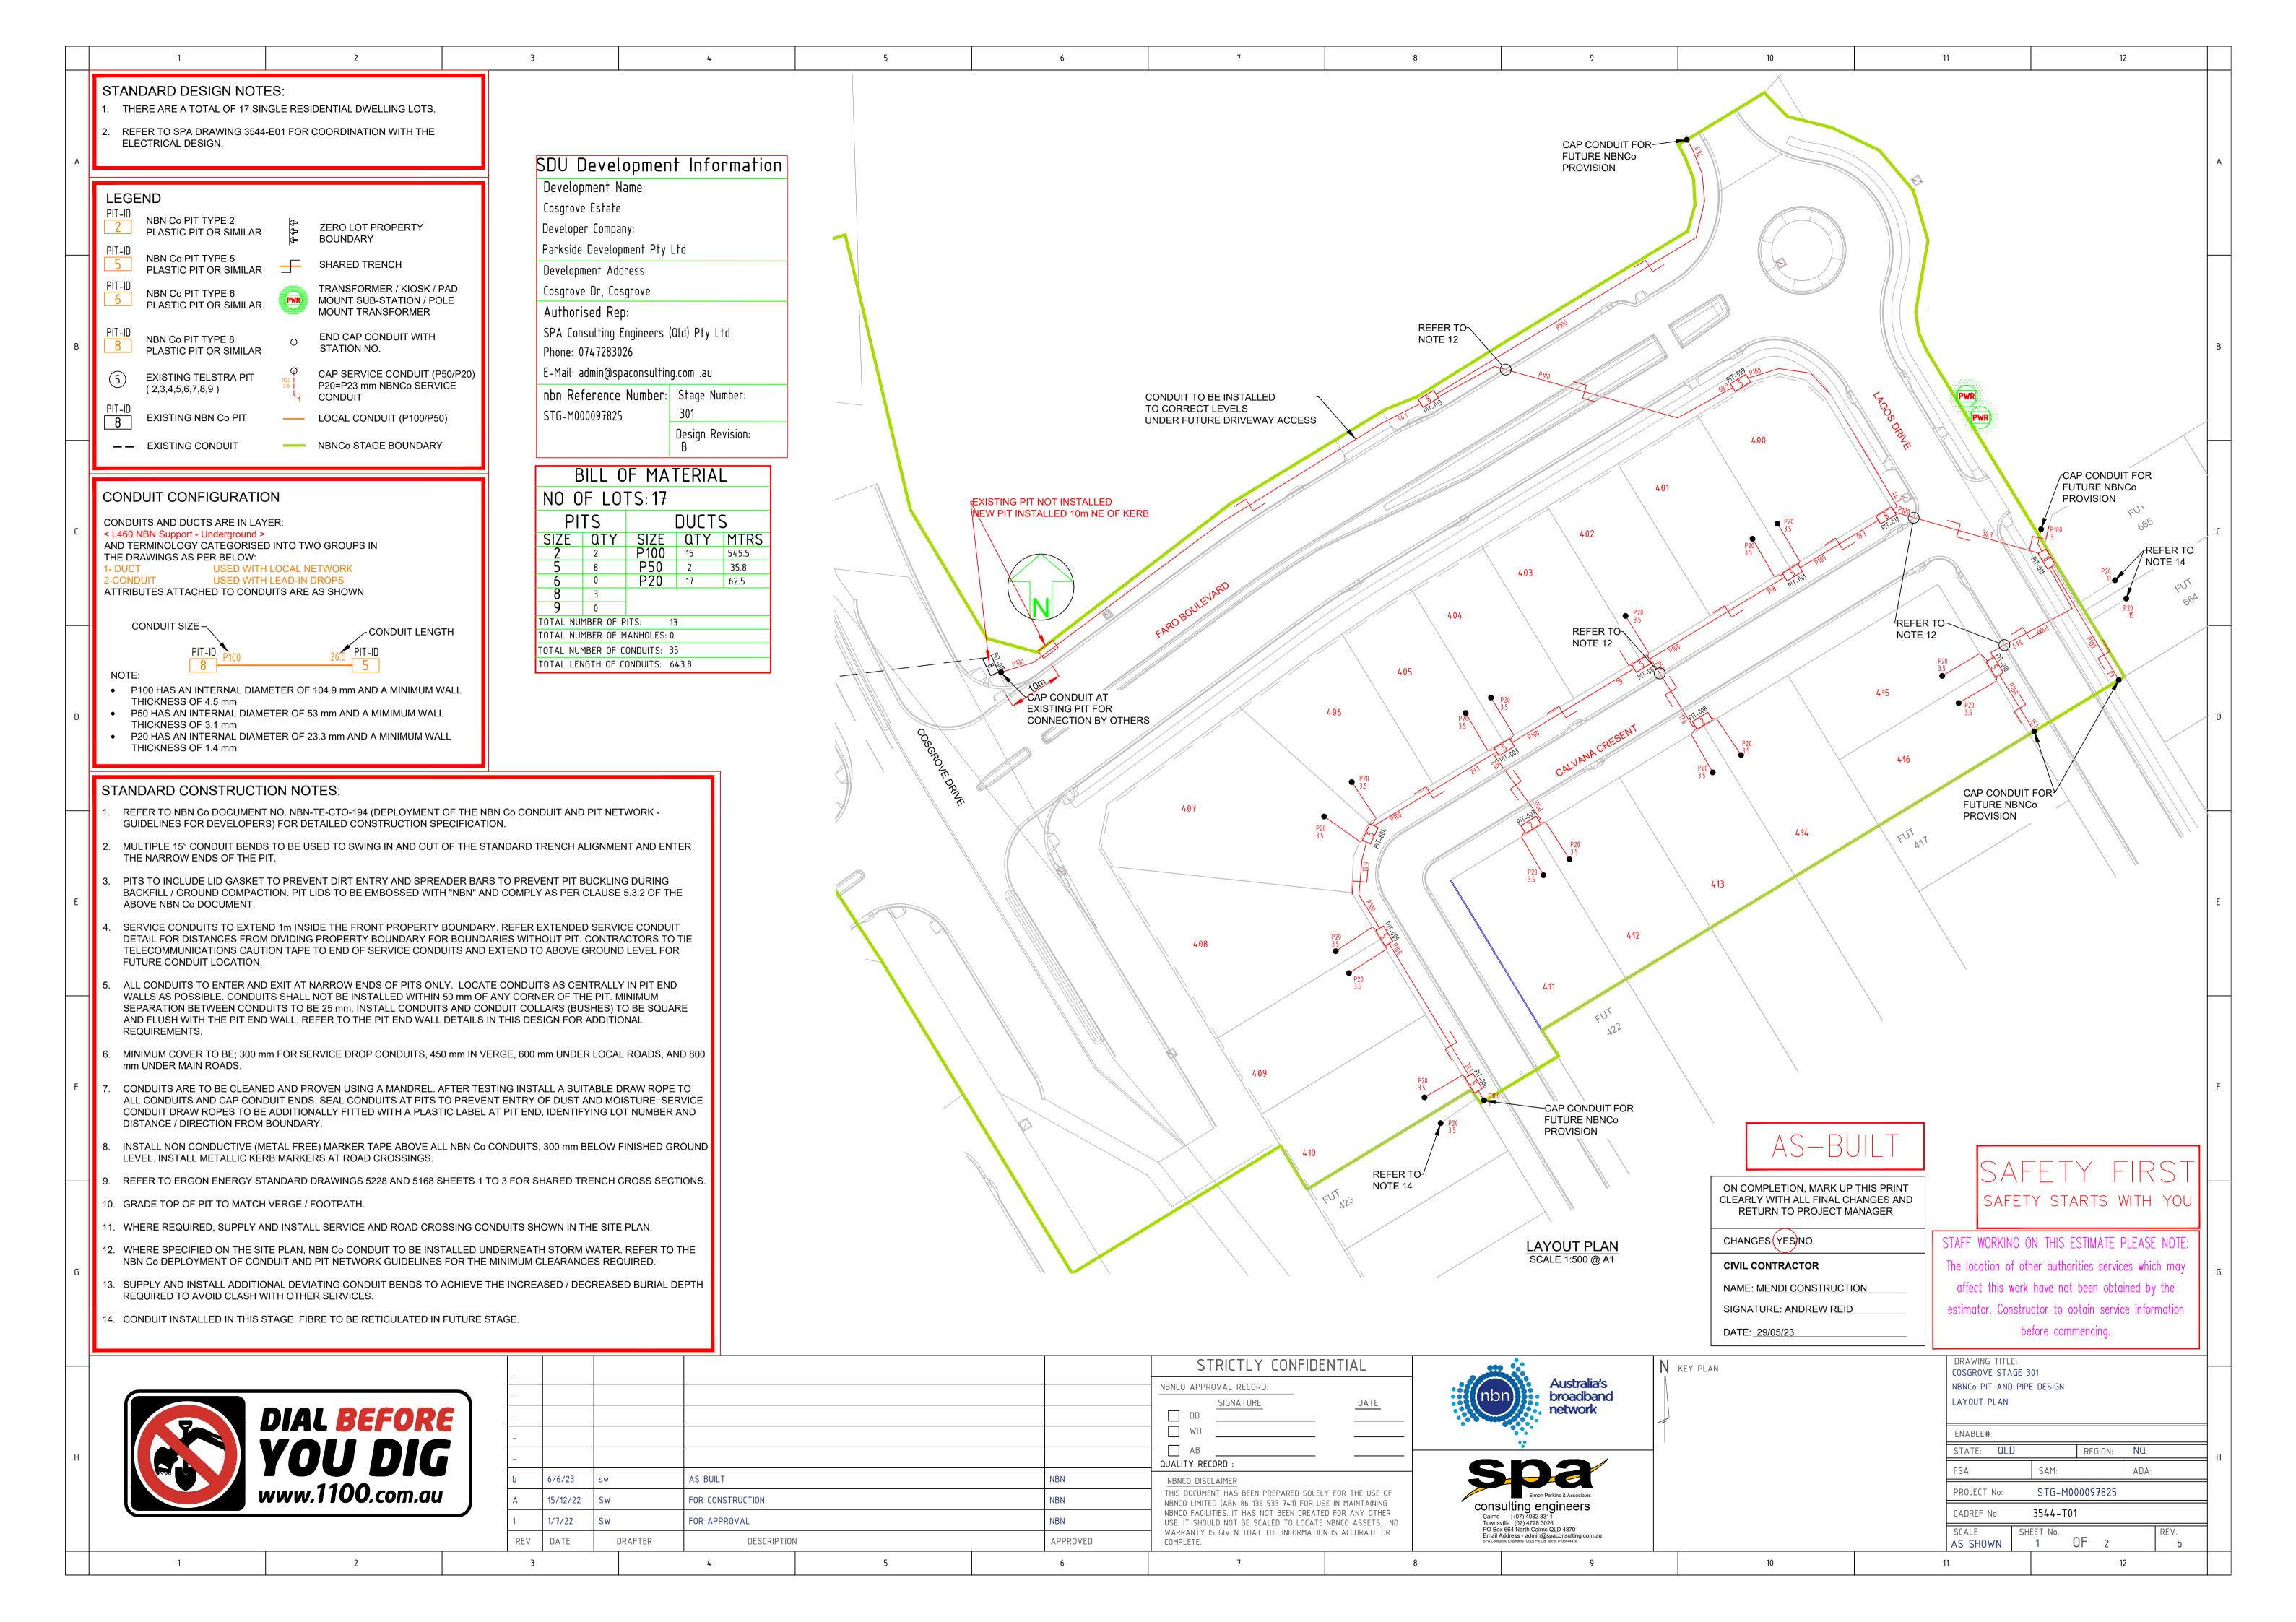

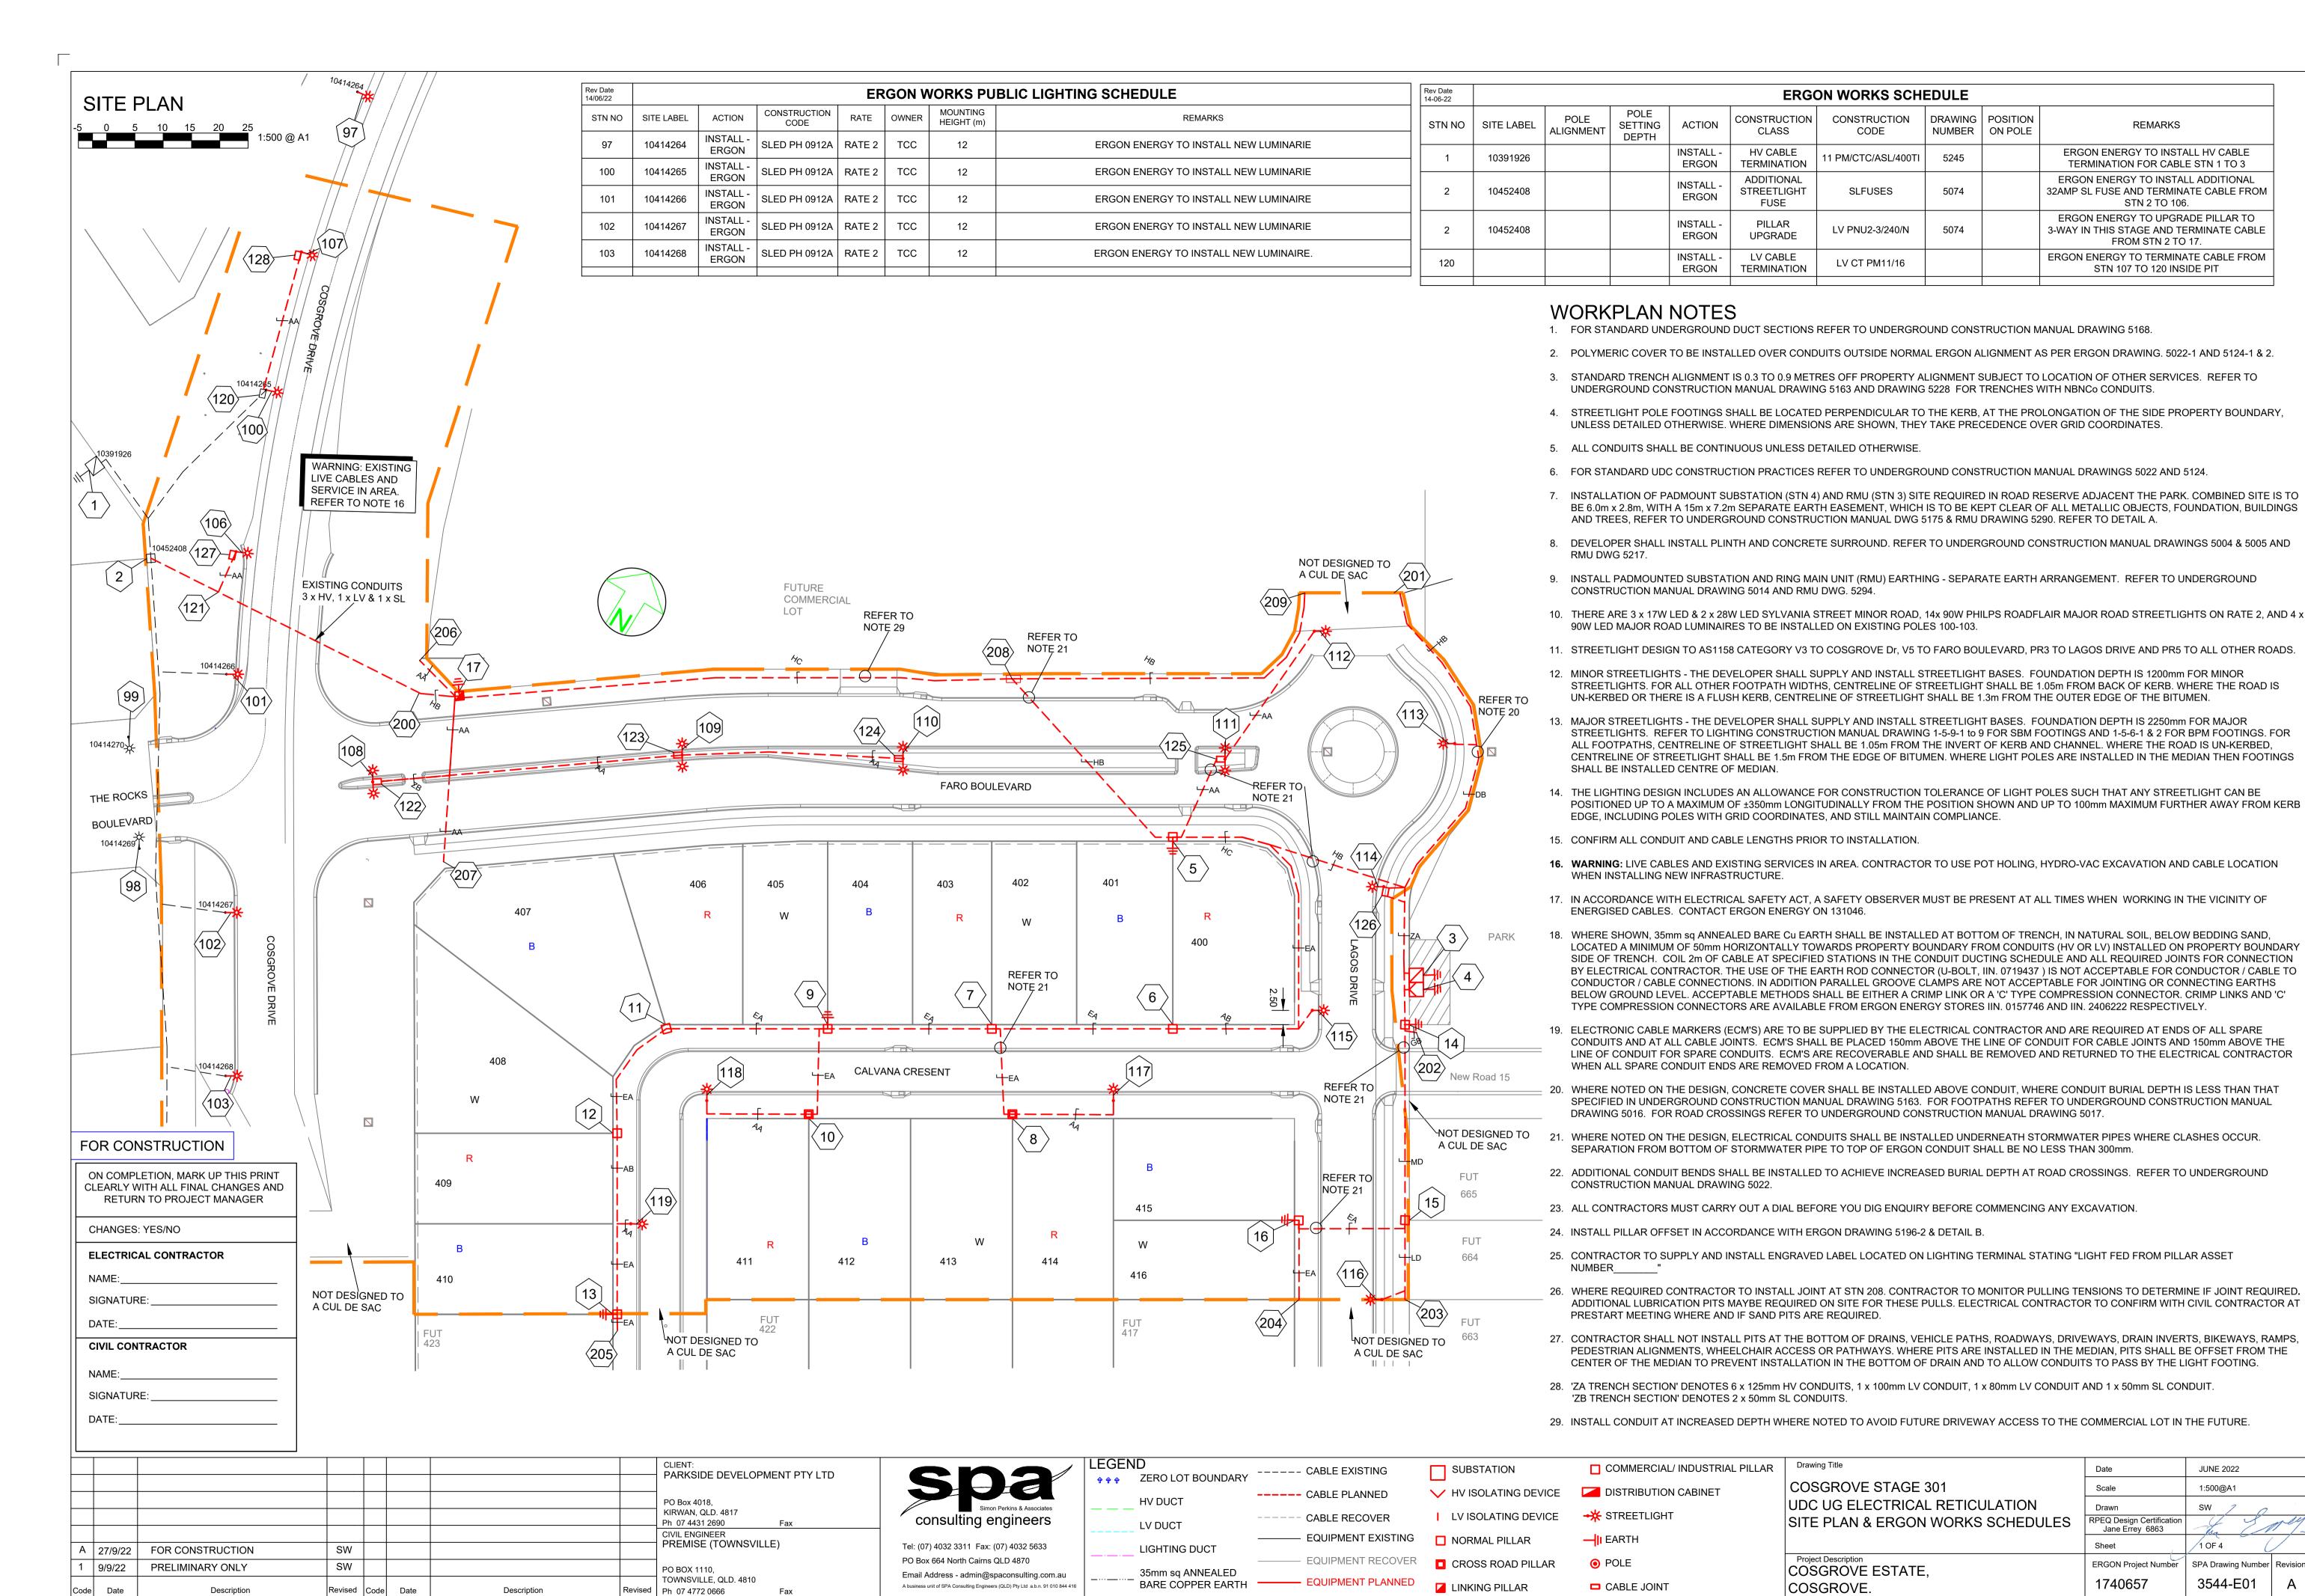

RPEQ Design Certification

Jane Errey 6863

ERGON Project Number

JUNE 2022

1:500@A1

SW 7

1 OF 4

SPA Drawing Number Revision

3544-E01

REMARKS

ERGON ENERGY TO INSTALL HV CABLE

TERMINATION FOR CABLE STN 1 TO 3

ERGON ENERGY TO INSTALL ADDITIONAL

32AMP SL FUSE AND TERMINATE CABLE FROM

STN 2 TO 106.

ERGON ENERGY TO UPGRADE PILLAR TO

3-WAY IN THIS STAGE AND TERMINATE CABLE

FROM STN 2 TO 17.

ERGON ENERGY TO TERMINATE CABLE FROM

STN 107 TO 120 INSIDE PIT