

NOTES:

- There are no existing or proposed
 - -drainage features
 - -retaining walls
 - -stormwater detention
- -community purposes land
- Easements as shown
- The final intended use of all allotments is for residential except if otherwise marked purposes in accordance with Cosgrove Plan of Development
- There are no buildings or structures over the land relevant to this stage
 Access into each allotment shall be via the road frontage. Specific
- locations to be determined at time of detailed engineering design and preparation of access envelopes.

DESIGN CODE - ALL ALLOTMENTS

Туре	House, Front Loaded
Lot Access	Front
Lot Depth (Min)	25m (20m where 15m width proposed)
Lot Width (Min)	12.5
Site Coverage	May exceed 50% in response to Code
-	Requirements, but no more than 60%
	Site Coverage.
Setback Front Ground (min) and upper (min)	3.5m
Setback Front Garage	6m and 1.5m behind front of dwelling
Setback Principal Side Ground (min)	QDC
Setback Principal Side Upper (min)	QDC
Setback Secondary Road Frontage (min)	2m
Garage setback Secondary Road Frontage(min)	3.5m
Setback Principal Rear (min)	1.5m (*Sewer lines and manholes may
	enforce greater setbacks)
Outbuilding (Shed) Width (max)	Lesser of 50% of rear boundary or 9m
Outbuilding (Shed) Depth (max)	9m
Outbuilding (Shed) Rear Setback	0-1.0m
Outbuilding (Shed) Side Setback	Zero if lot 12.5m wide. As per Principal
	setback if lot >12.5m wide
Floor Height Principal (min)	400mm
Maximum Storeys	As per the Applicable Scheme
Private Open Space (min) (may be covered)	4mx4m
Parking (min)	Two (2),one of which must be covered

*Note: Clearances to sewer lines and manholes are required in accordance with council policy

This plan is conceptual and for discussion purposes only. All areas, dimensions and land uses are preliminary, subject to investigation, survey, engineering, and Local Authority and Agency approvals.

PROPOSED RECONFIGURATION


Lots 157-165, 187-197 and 904 Cancelling Lot 900 on SP264422

Parish of Coonambelah County of Elphinstone City of Townsville

CORNER SIGHT LINES

Comply with sight lines requirement of the Queensland Development code on road corners. This is typically a 9m x 9m exclusion zone based on boundaries.

For clipped corners, footpaths wider than 4.2m and lots with park frontages typically this is a 18m x 18m exclusion zone based on edge of traffic lane. Rear access lanes are exempted from this requirement.

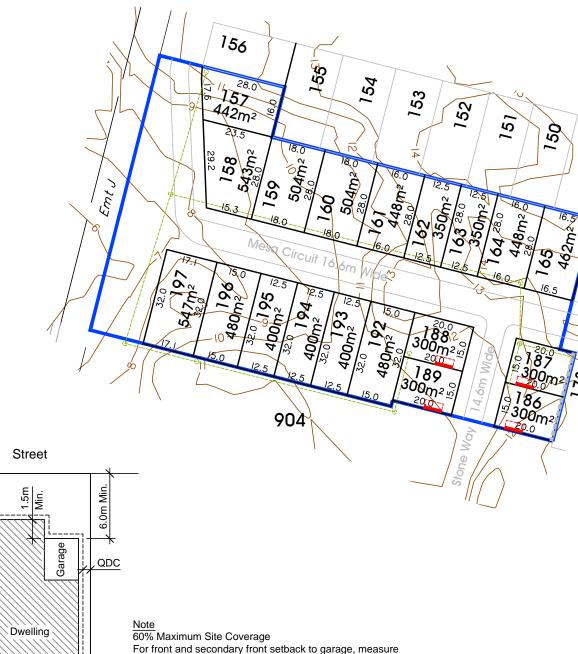

For front and secondary front setback to garage, measure from the front boundary to the garage opening (wall). All other setbacks are measured from the boundary


to the outermost projection (including carports).

Typical Setback Requirements Not to Scale

QDC


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1.5m Subje Servid

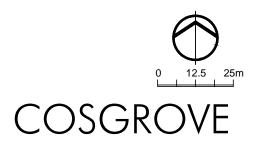

STAGE 202

Total Stage Area	1.24 ha
Number of Lots	19
Average Lot Area	424m²
Total Length of New Road	222m




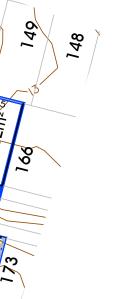

1.0m contour Stage Boundary Proposed Retaining Wall Assumed Sewer Layout Build to Boundary Setback



Date: 10th October, 2014 Scale: 1:1250 @ A3 Drawn: AJL

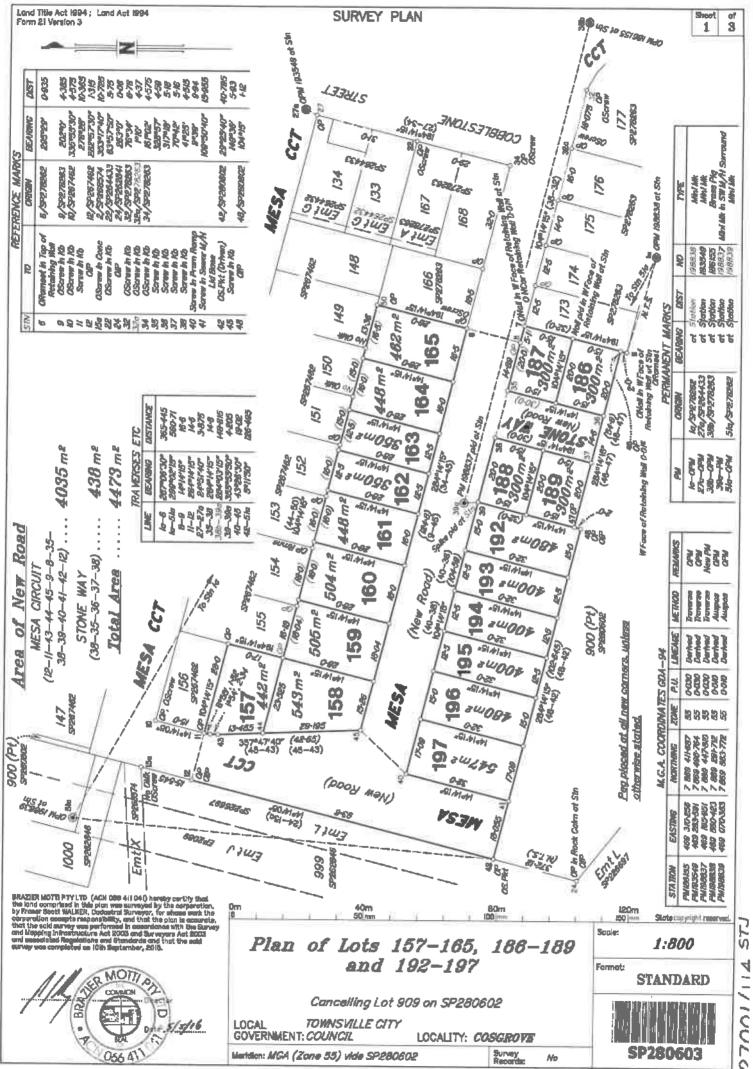

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(Names in full) *ex Registered Owners of this land egres to this plan and deficate the Public Use Land as shown harves in excordance with Section 50 of the Land Title Ast. 1994, * as Leasees of this land agree to this plan. Signature of *Registered Owners *Leasees Divertion	 EXI:	STING ADMINIST Administrative Advia 712782882 714701976	Lots to be 157-165, 186	ALLOCATION e Encumbersd 6 189 & 192 19 189 & 192 19	7
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Survey Report

- This plan subdivides the "super" Lot 909 created on SP280602.
- All OP's and existing reference marks located, agreed with the dimensions shown on SP284433, SP267462, SP278263 and SP280602 to within survey accuracies.
- The OP's shown from Stn 12 through Stn 11, then southwards and thence eastwards to Stn 50 confirmed the alignments shown as original on SP280602.
- No reinstatement was necessary as all original monuments and references were found from Lot 909. It having been surveyed just prior to this survey.
- MGA Meridian was previously checked on 8P280602 by traversing between the OPM,s 198838 &198839 and corners of Lot 909. Checks were also observed for the line between OPM185155 and PM198837 (38a-38b).

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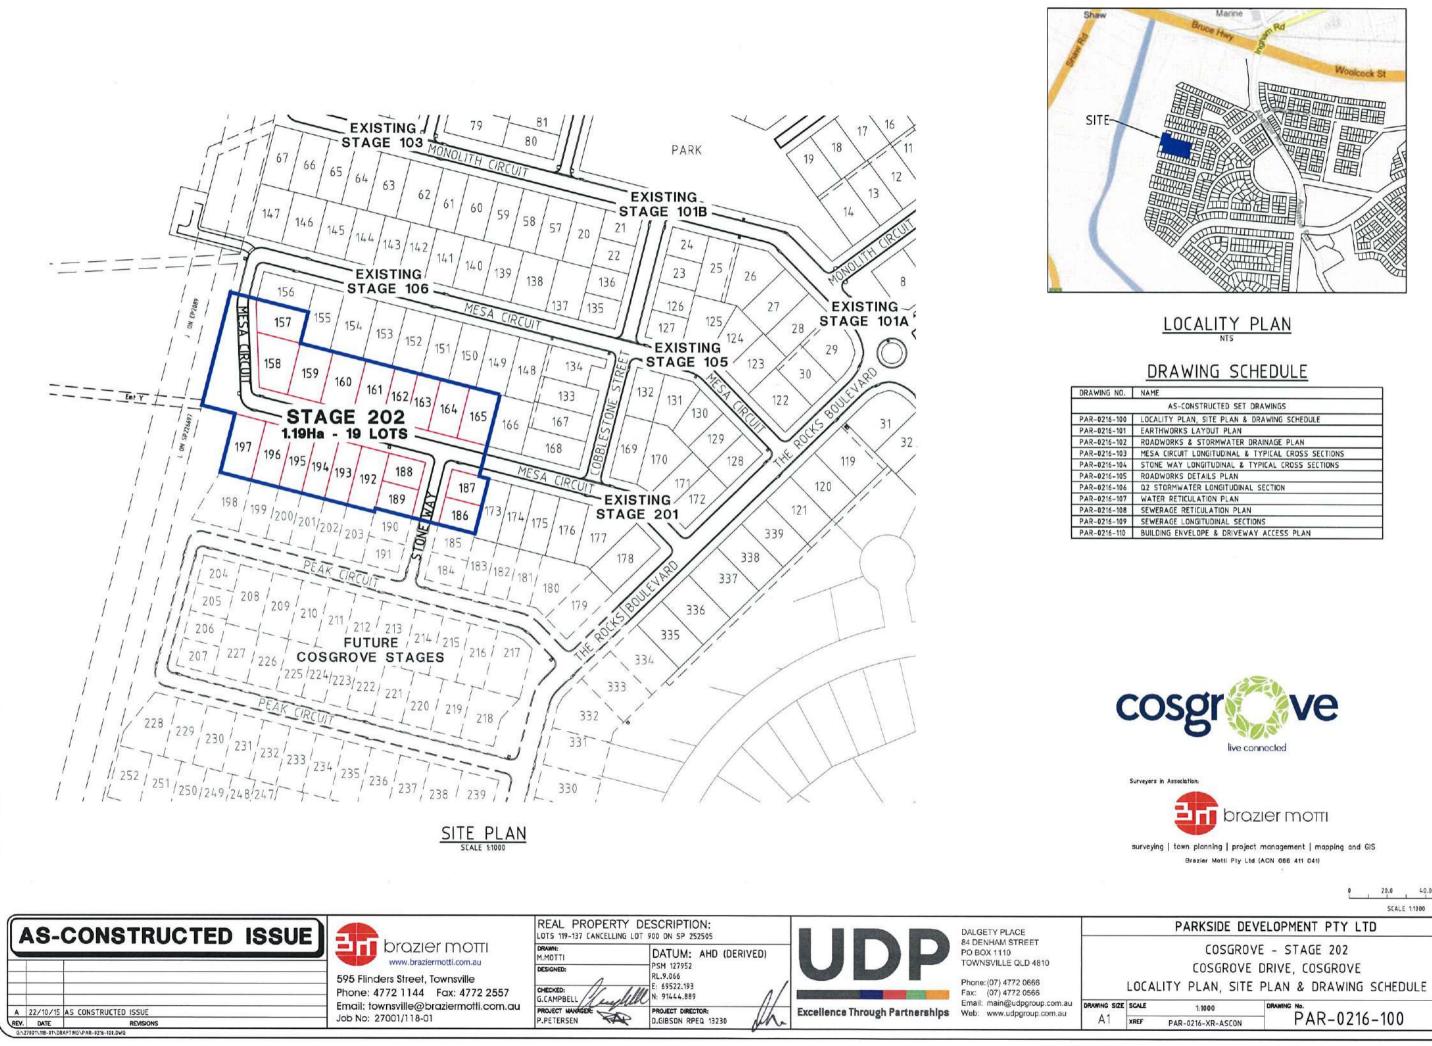
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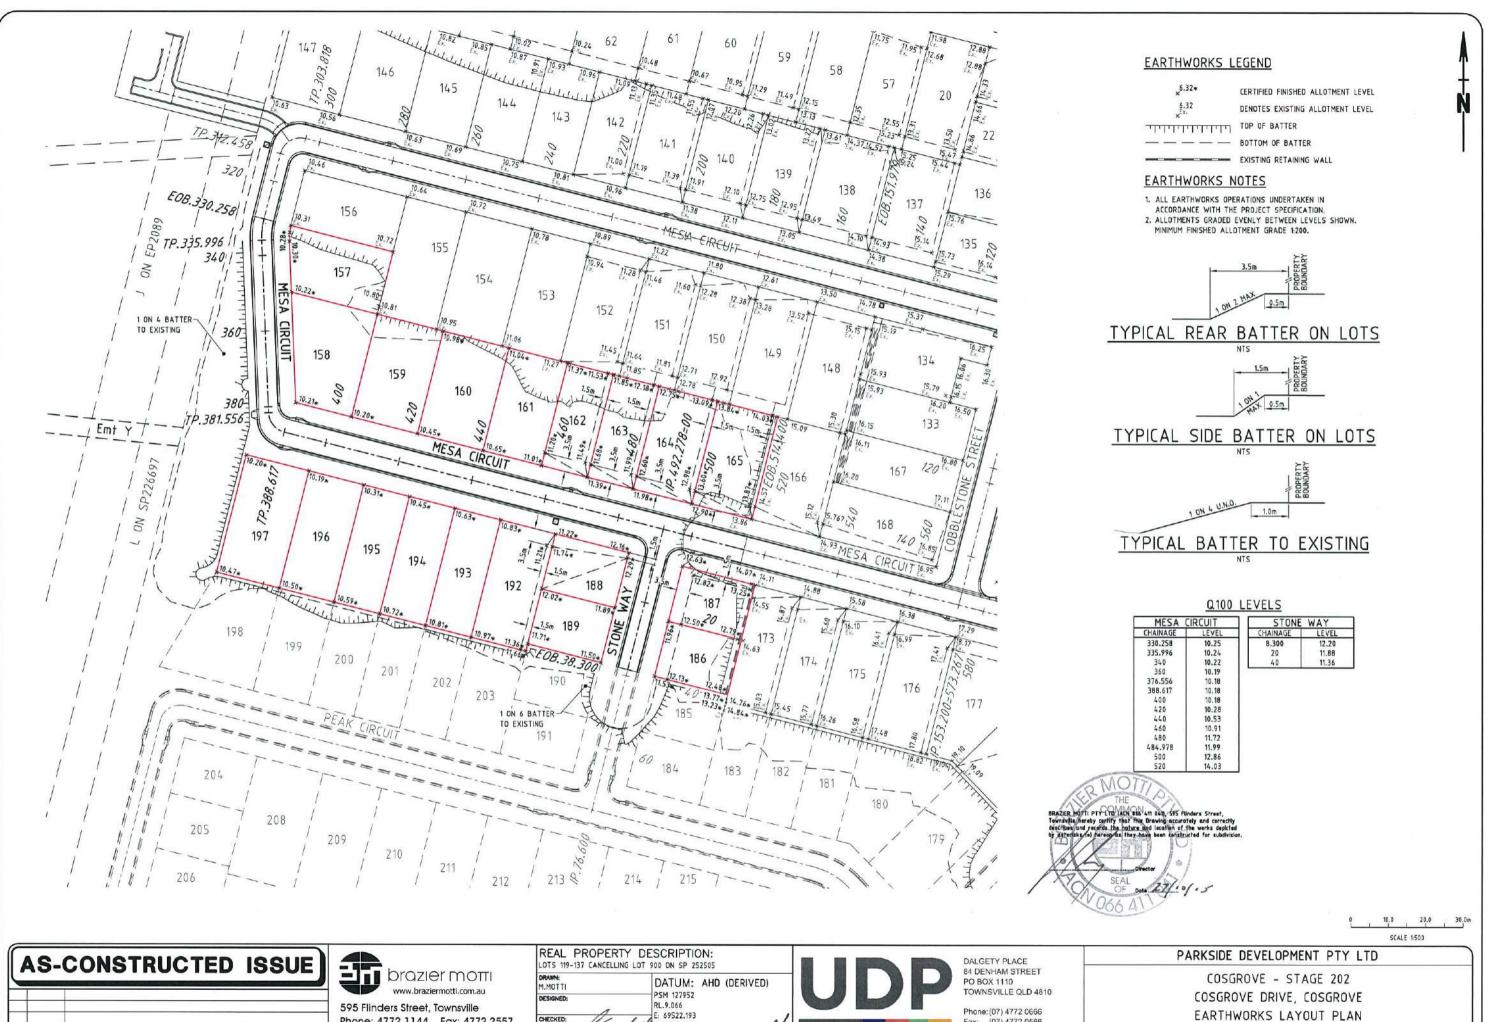
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AS-CONSTRUCTED SET DRAWINGS	
DCALITY PLAN, SITE PLAN & DRAWING SCHEDULE	
ARTHWORKS LAYOUT PLAN	
OADWORKS & STORMWATER DRAINAGE PLAN	
ESA CIRCUIT LONGITUDINAL & TYPICAL CROSS SECTIONS	
TONE WAY LONGITUDINAL & TYPICAL CROSS SECTIONS	
OADWORKS DETAILS PLAN	
2 STORMWATER LONGITUDINAL SECTION	
ATER RETICULATION PLAN	
EWERAGE RETICULATION PLAN	
EWERAGE LONGITUDINAL SECTIONS	
UILDING ENVELOPE & DRIVEWAY ACCESS PLAN	

20.0 40.0 60.0m SCALE 1:1000

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	A	22/10/15	AS CONSTRUCTED ISSUE	
1	1000	122020202		

REV. DATE

Email: townsville@braziermotti.com.au Job No: 27001/118-01

Phone: 4772 1144 Fax: 4772 2557



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PAR-0216-101




AS-CONSTRUCTED ISSUE



595 Flinders Street, Townsville Phone: 4772 1144 Fax: 4772 2557 Email: townsville@braziermotti.com.au Job No: 27001/118-01

REAL PROPERTY LOTS 119-137 CANCELLING			DALGETY PLACE 84 DENHAM STREET	
DRAWN: M.MOTTI	DATUM: AHD (DERIVED)		PO BOX 1110 TOWNSVILLE QLD 4810	
	PSM 127952 RL.9.066 E: 69522.193 M: 91444.889	ODF	Phone:(07) 4772 0666 Fax: (07) 4772 0566	R
G.CAMPBELL PROJECT MANAGÉR: P.PETERSEN	PROJECT DIRECTOR: D.GIBSON RPEQ 13230	Excellence Through Partnerships	Email: main@udpgroup.com.au Web: www.udpgroup.com.au	A 1 XREF

A 22/10/15 AS CONSTRUCTED ISSUE REV. DATE REVISIONS

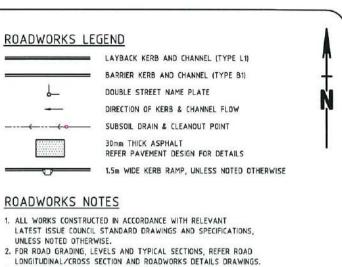

3. FOR SUBSOIL DRAIN DETAILS, REFER DRAWING PAR-0216-105. 4. ALL SUBSOIL DRAINS GRADED AT MINIMUM 0.5% FROM HIGH POINT TO OUTLET, UNLESS NOTED OTHERWISE.

5. SUBSOIL DRAIN REVERSED GRADED AT MINIMUM 0.5% TO ENSURE POSITIVE GRADE.

STORMWATER LEGEND:

D	STORMWATER DRAINAGE LINE
3/1	STORMWATER MANHOLE (MANHOLE NO./LINE NO.)
1/12	KERB INLET PIT (PIT NO./LINE NO.)
— - D - — - D - —	EXISTING STORMWATER DRAINAGE LINE
Ex.6/1	EXISTING STORMWATER MANHOLE (MANHOLE NO./LINE NO.)
Ex.1/13	EXISTING KERB INLET PIT (PIT NO./LINE NO.)
5	SEWERAGE RETICULATION
SS	EXISTING SEWERAGE RETICULATION

STORMWATER NOTES

1. ALL WORKS CONSTRUCTED IN ACCORDANCE WITH RELEVANT LATEST ISSUE COUNCIL STANDARD DRAWINGS AND SPECIFICATIONS, UNLESS NOTED OTHERWISE.

- FOR STORMWATER LEVELS, PIPE LENGTHS, PIPE CLASS AND STRUCTURE TYPES, REFER STORMWATER LONGITUDINAL DRAWINGS.
- 3. ALL PIPE AND BOX CULVERT CUTS MADE USING A MASONRY SAW.
- 4. ALL TRENCHES UNDER ROAD PAVEMENT
- BACKFILLED WITH CRUSHER DUST TO SUBGRADE LEVEL. 5. FOR REVEGETATION DETAILS REFER TO PROJECT SPECIFICATION.
- 6. REFER DETAIL ON DRAWING PAR-0216-105 FOR TYPICAL SUBSURFACE
- DRAINAGE TO STORMWATER MANHOLES. 7. FOR STORMWATER KERB INLET TRANSITION DETAILS, REFER DRAWING PAR-0216-105.




PARKSIDE DEVELOPMENT PTY LTD

COSGROVE - STAGE 202 COSGROVE DRIVE, COSGROVE ROADWORKS & STORMWATER DRAINAGE PLAN

1.500

PAR-0216-102 PAR-0216-XR-ASCON

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PROPERTY BOUNDARY 0.6m 4.2m 1.0m TURF STRIP 2.0%-4.0%

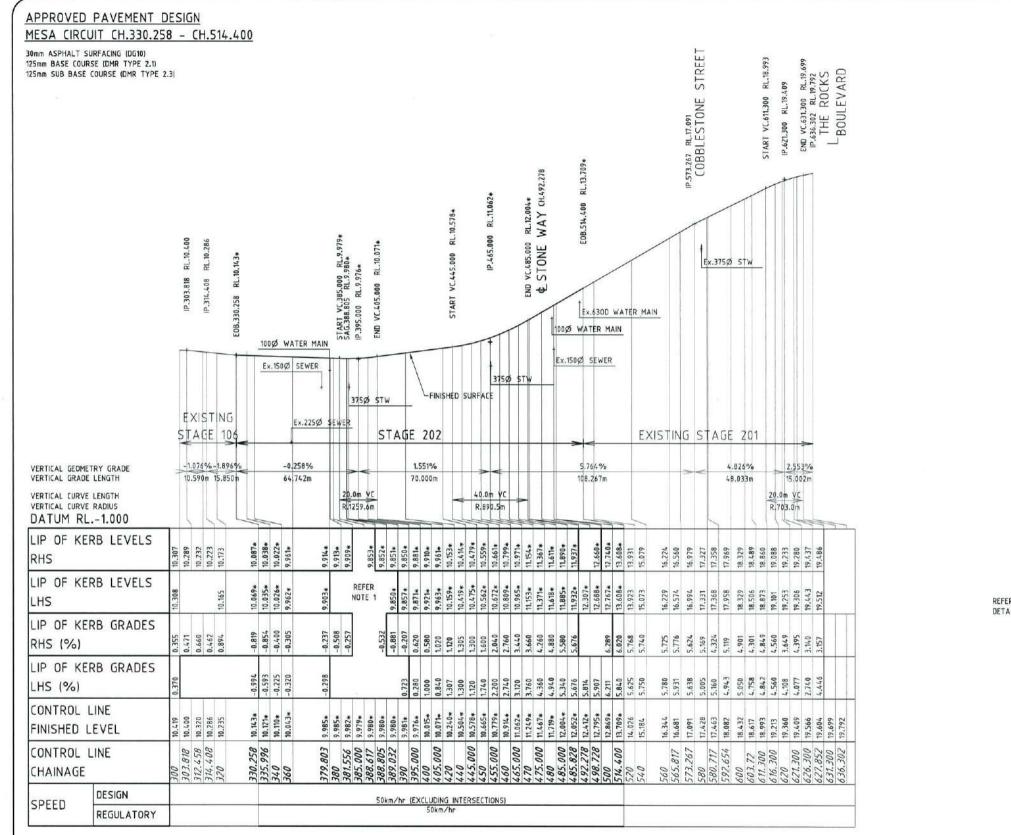1.0m TURF STRIP 2.0%-4.0% REFER PAVEMENT & KERBING -E DETAIL (B) DRAWING PAR-0216-105


MESA CIRCUIT LONGITUDINAL SECTION

SCALE 1:100 VERTICAL, SCALE 1:1000 HORIZONTAL

NOTES:

1. FOR LEVEL INFORMATION REFER ROADWORKS DETAILS PLAN.

AS-CONSTRUCTED ISSUE		REAL PROPERTY DESCRIPTION: LOTS 119-137 CANCELLING LOT 900 ON SP 252505		DALGETY PLACE 84 DENHAM STREET	
		DRAWN: M.NOTTI DESIGNED: RL.9.066	UDP	PO BOX 1110 TOWNSVILLE QLD 4810	
	595 Flinders Street, Townsville Phone: 4772 1144 Fax: 4772 2557	CHECKED: E: 69522.193		Phone: (07) 4772 0666 Fax: (07) 4772 0566 Email: main@udpgroup.com.au	MESA CI
A 22/10/15 AS CONSTRUCTED ISSUE REV. DATE REVISIONS	Email: townsville@braziermotti.com.au Job No: 27001/118-01	G.CAMPBELL CALL Nº 91444.889 PROJECT DIRECTOR: P.PETERSEN D.GIBSON RPEQ 13230	Excellence Through Partnerships	Web: www.udpgroup.com.au	A 1 XREF
G\27011\11F-G\\DRAFTING\PAR-0216-113.0WG					•

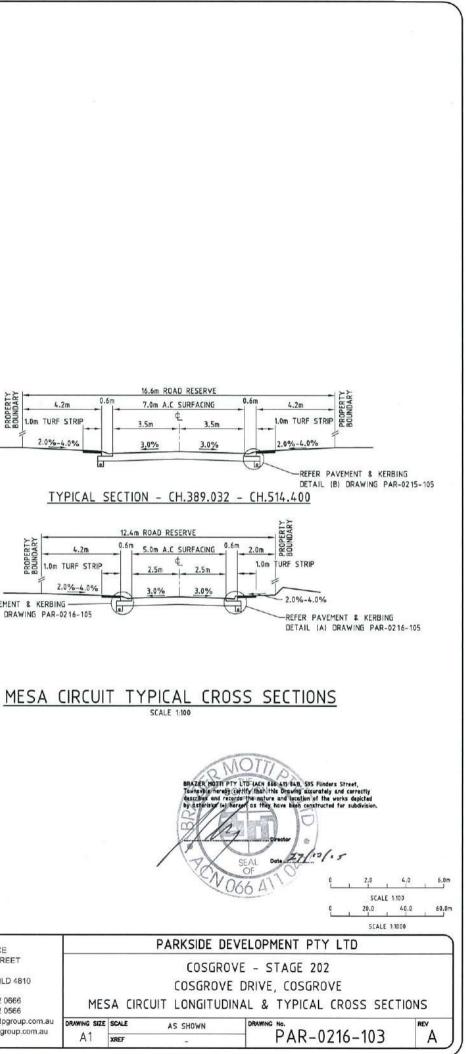

APPROVED PAVEMENT DESIGN STONE WAY CH.00 - CH.38.300

30mm ASPHALT SURFACING (DG10) 125mm BASE COURSE (DMR TYPE 2.1) 125mm SUB BASE COURSE (DMR TYPE 2.3)

RL.12.412+ CIRCUIT CIRCUIT PEAK ÷ START VC.30.000 RL EDB.38.300 RL.11.396* IP.40.000 RL.11.290 11.100 11.100 11.160 11.251 RL 120 .000 RL.13 RL. IP.0.000 END VC.50. IP.55.000 1000 1000 IP.65.0 IP.69.1 IP.73.1 IP.76.6 1000 WATER MAIN NSHED SURFACE Ex.375Ø STW LEXISTING SURFACE FUTURE STAGES STAGE 202 -0-400% VERTICAL GEOMETRY GRADE VERTICAL GRADE LENGTH -2.805% 40.000m 4.150 10.000 VERTICAL CURVE LENGTH VERTICAL CURVE RADIUS DATUM RL.2.000 LIP OF KERB LEVELS 1.779* RHS LIP OF KERB LEVELS 1.778* L369, LHS EFER LIP OF KERB GRADES -2.820 -2.640 -1.939 805 RHS (%) LIP OF KERB GRADES -2.760 -2.660 -2.030 E. LHS (%) CONTROL LINE .854+ 12.217+ FINISHED LEVEL CONTROL LINE 300 7.450 000 50U CHAINAGE 20 30. 50km/hr EXCLUDING INTERSECTIONS) DESIGN SPEED 50km/h REGULATORY

STONE WAY LONGITUDINAL SECTION SCALE 1:100 VERTICAL, SCALE 1:100 HORIZONTAL

 14.6m ROAD RESERVE

 4.2m
 0.6m
 5.0m
 A.C
 SURFACING
 0.6m

 1.0m
 TURF STRIP
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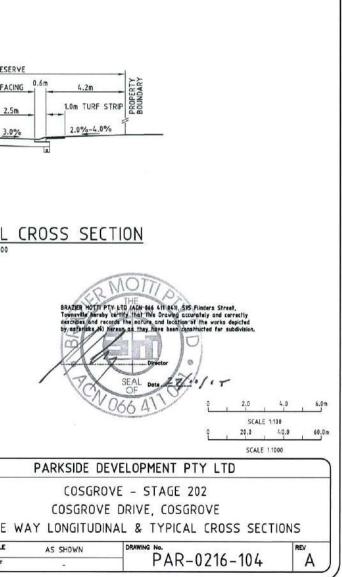
STONE WAY TYPICAL CROSS SECTION


SCALE 1:100




1. FOR LEVEL INFORMATION REFER ROADWORKS DETAILS PLAN.


AS-CONSTRUCTED ISSUE		REAL PROPERTY DESCRIPTION: LOTS 119-137 CANCELLING LOT 900 ON SP 252505		DALGETY PLACE 84 DENHAM STREET	
	www.braziermotti.com.au 595 Flinders Street, Townsville Phone: 4772 1144 Fax: 4772 2557	DRAWNE: DATUM: AHD (DERIVED) MMOTTI PSM 127952 PSM 127952 DESIGNED: E: 69522.193 E: 69522.193 G.CAMPBELL G.CAMPBELL G.CAMPBELL G.CAMPBELL	UDP	PO BOX 1110 TOWNSVILLE QLD 4810 Phone: (07) 4772 0666 Fax: (07) 4772 0566 Email: main@udpgroup.com.au	
A 22/10/15 AS CONSTRUCTED ISSUE REV. DATE REVISIONS GL2701119-RURBAFTINGSPAR-0214-114.DWB	Job No: 27001/118-01	PROJECT MUNUCER: P.PETERSEN PROJECT DIRECTOR: D.GIBSON RPEQ 13230	Excellence Through Partnerships	Web: www.udpgroup.com.au	A1 XREF



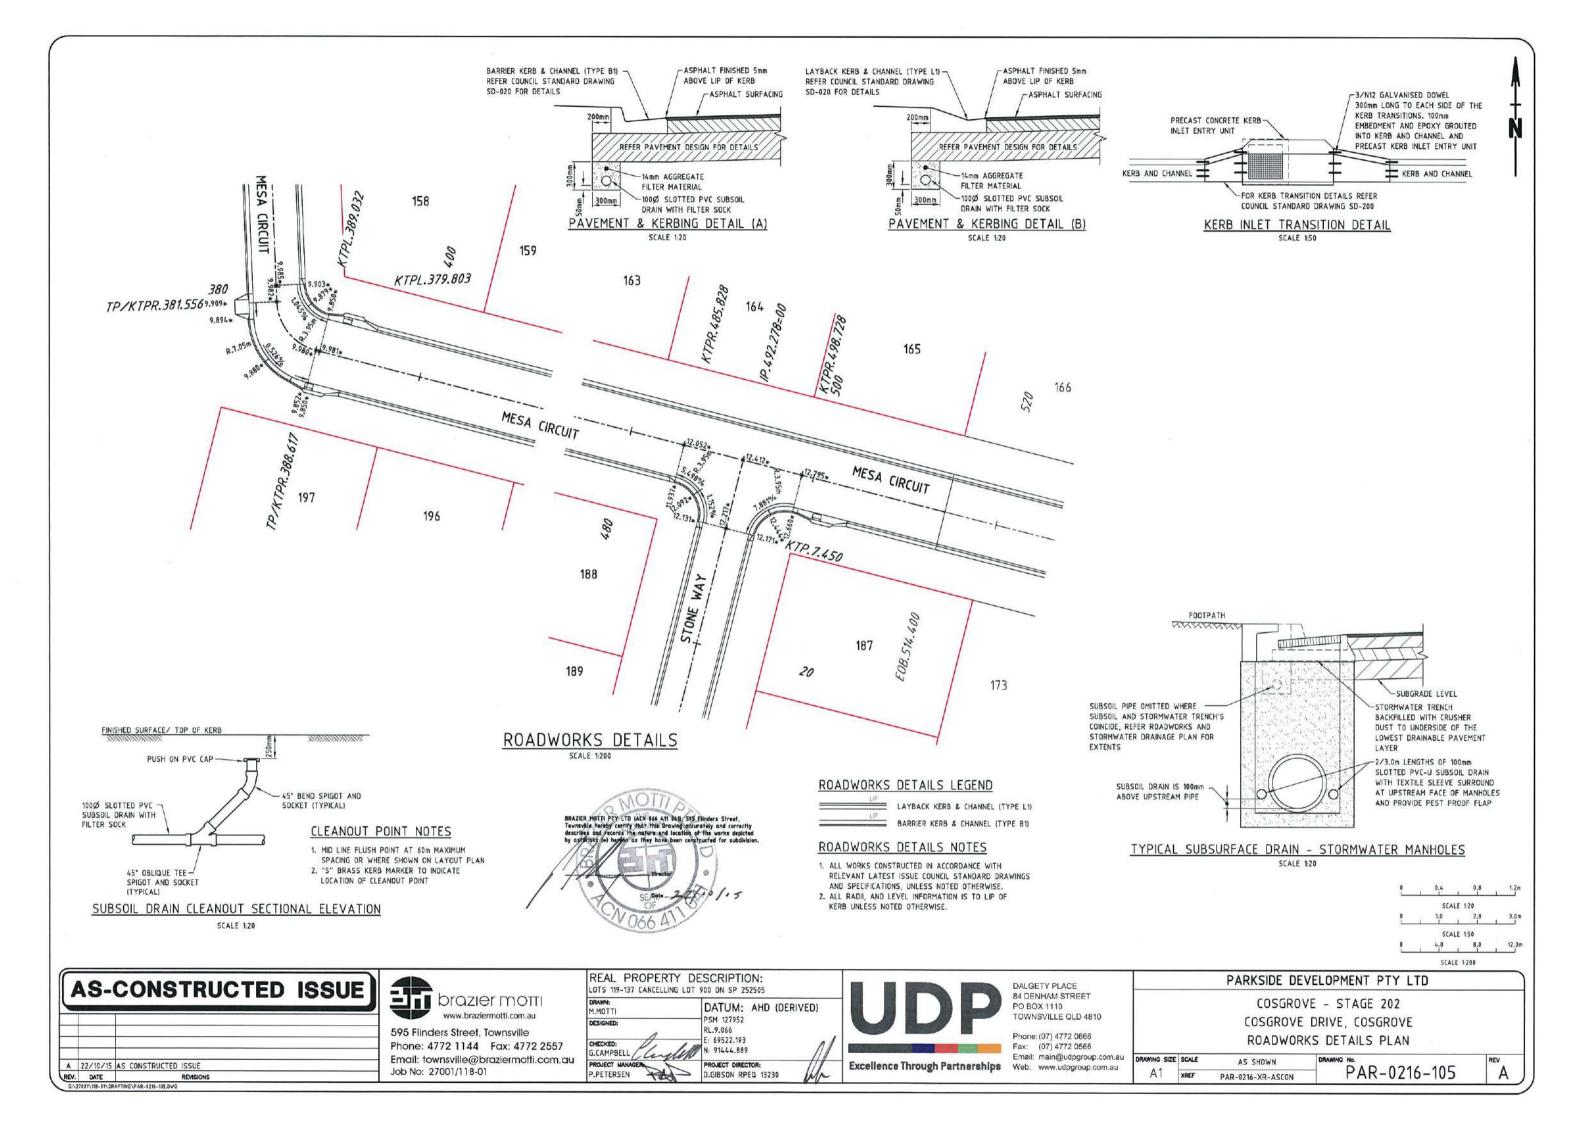

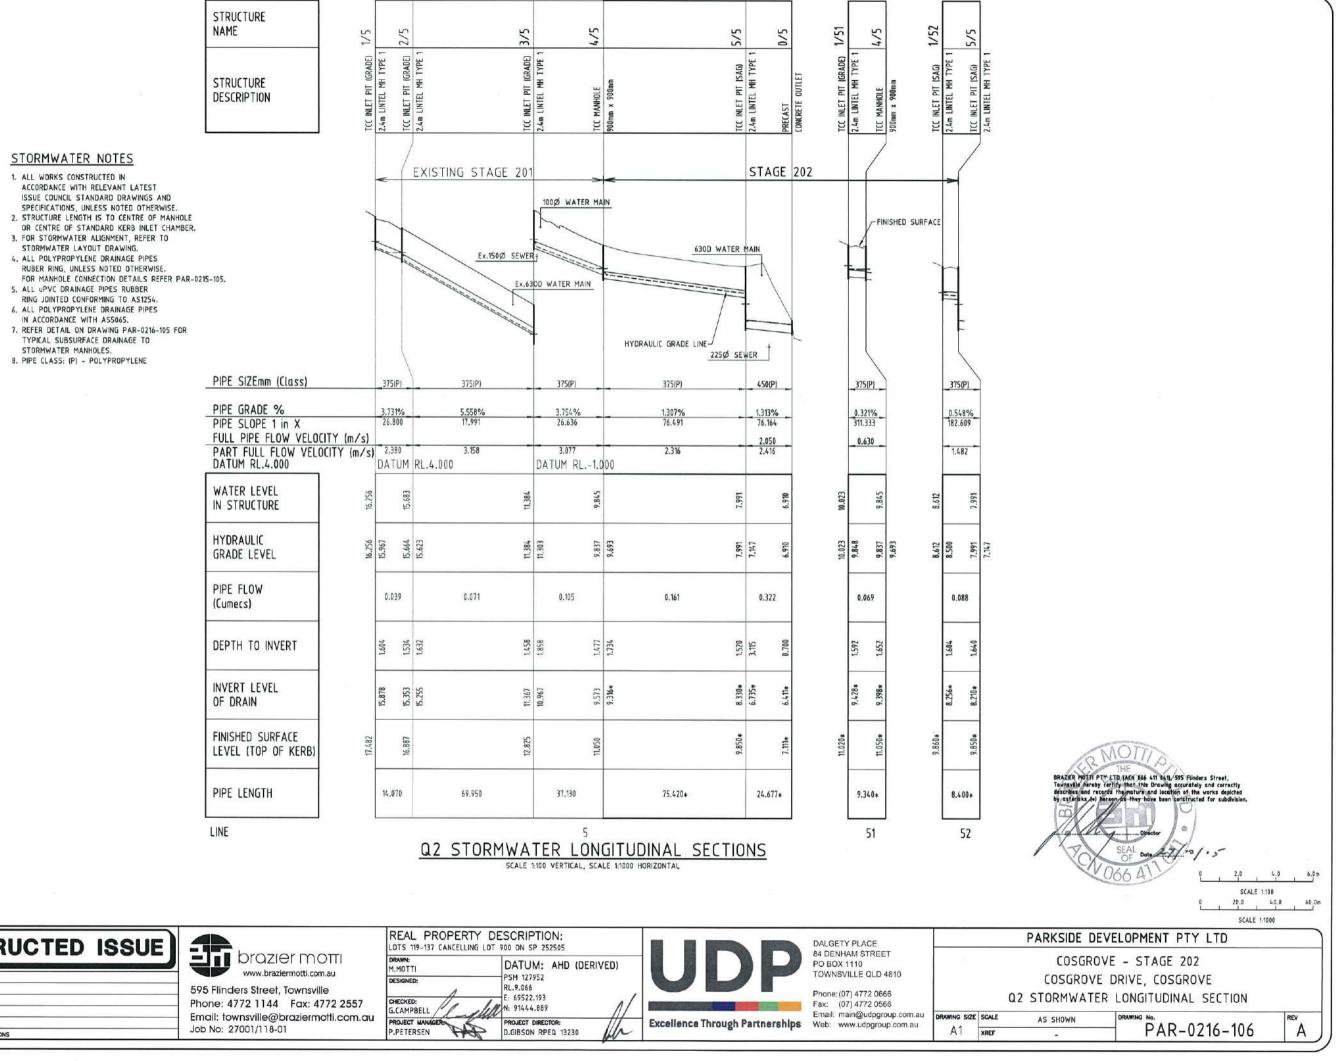


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GI-27637L118-D1/DRAFTING/PAR-0216-186.DWG					

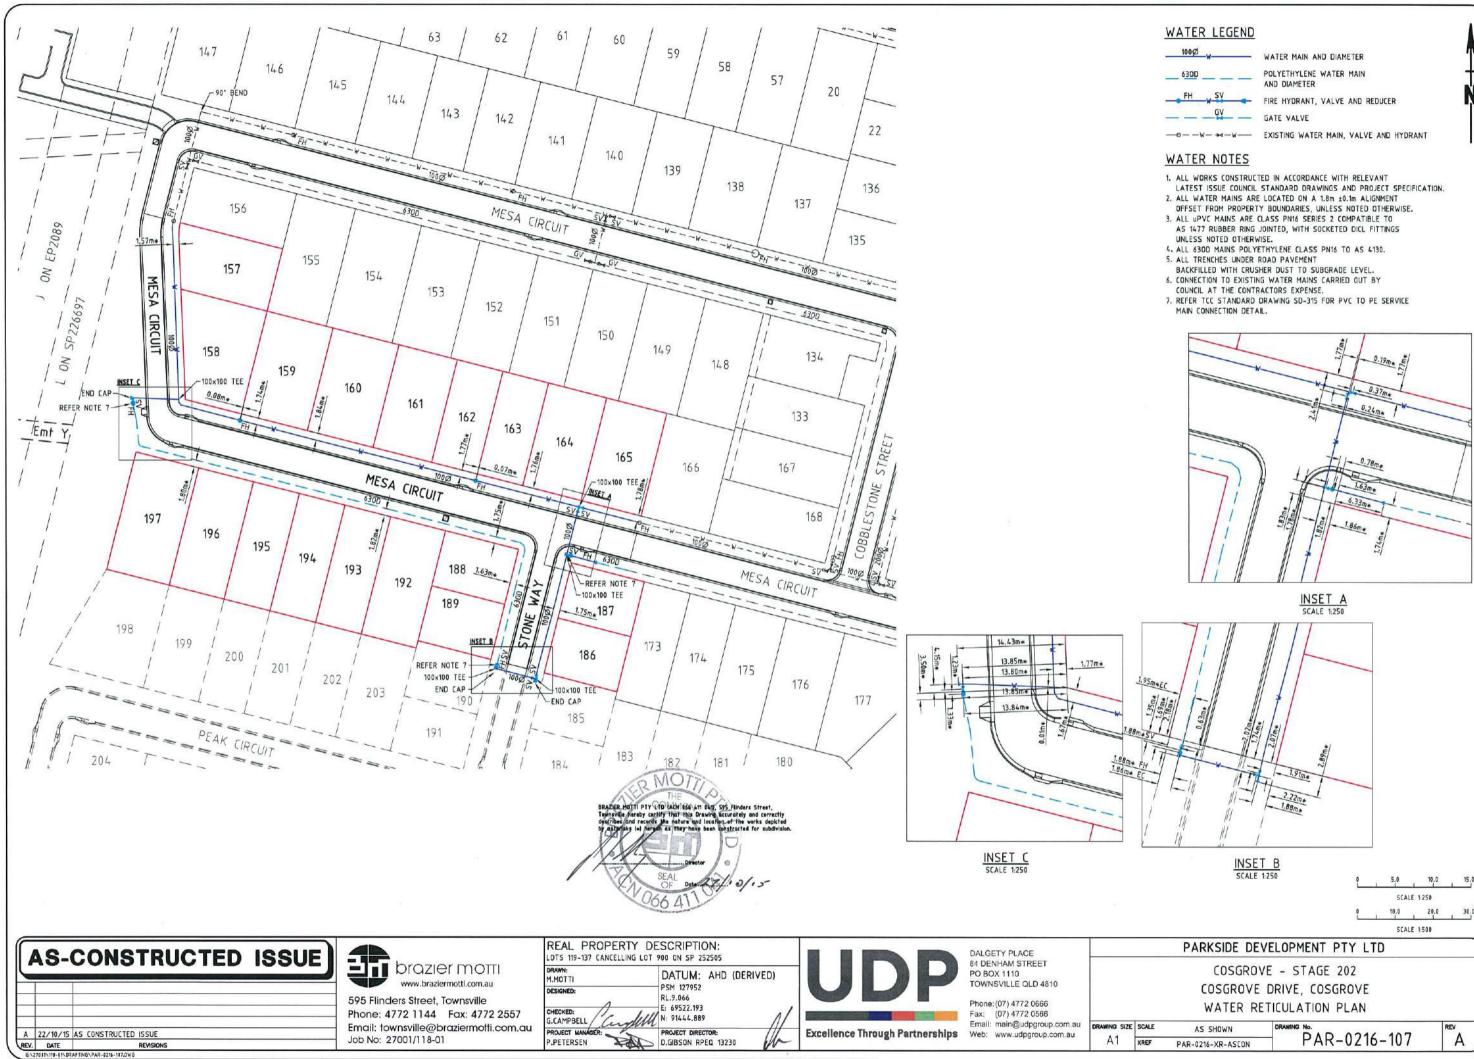


10.0 15.0m 30.0m

			SCALE 1500
	PARKSIDE DEVI	ELOPMENT PTY LTD	
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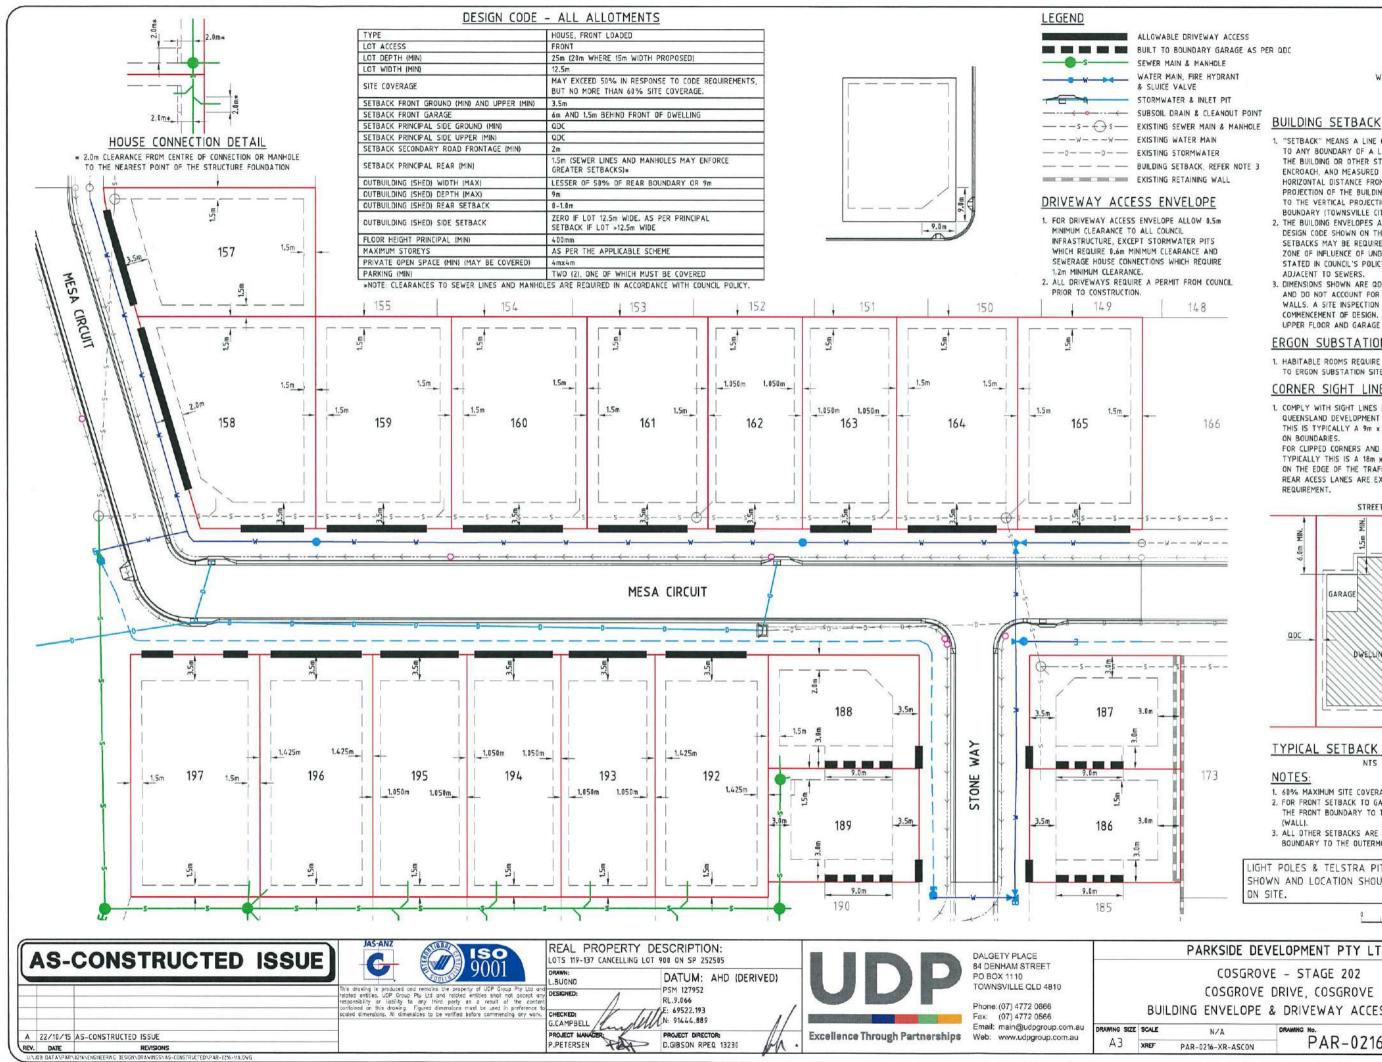

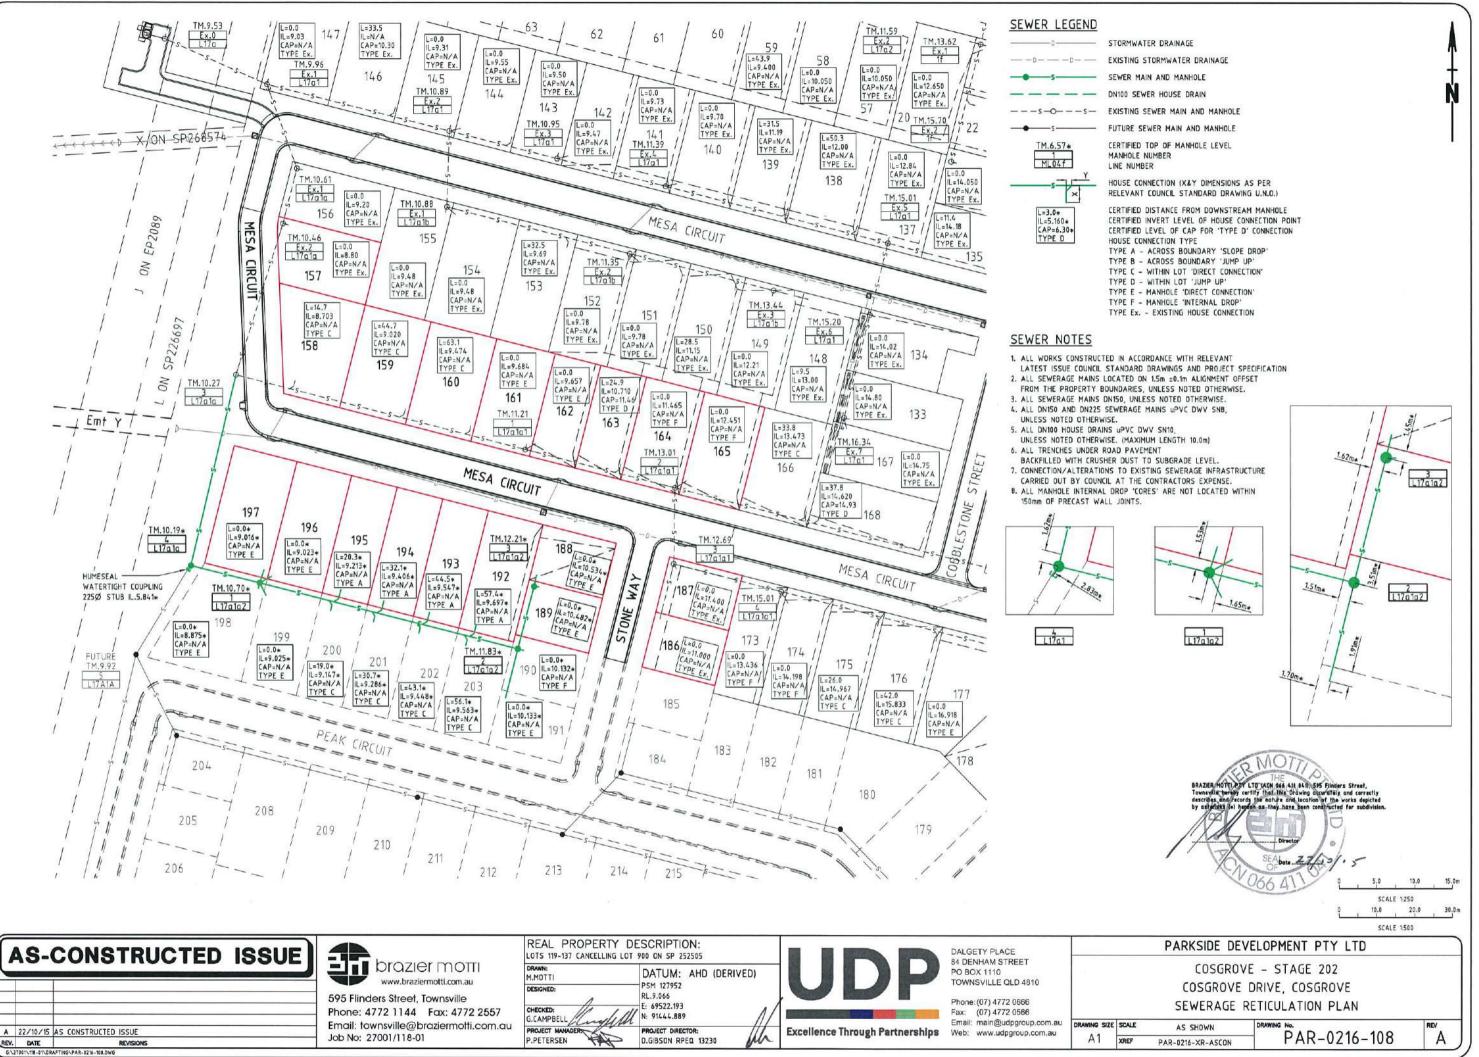
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		DRAWN: M.MOTTI DESIGNED:	DATUM: AHD (DERIVED) PSM 127952	UDP	PO BOX 1110 TOWNSVILLE QLD 4810	
	595 Flinders Street, Townsville Phone: 4772 1144 Fax: 4772 2557	CHECKED: G.CAMPBELL	RL.9.066 E: 69522.193 N: 91444.889		Phone: (07) 4772 0666 Fax: (07) 4772 0566 Email: main@udpgroup.com.au	DRAWING SIZE SCALE
A 22/10/15 AS CONSTRUCTED ISSUE Rev. DATE REVISIONS	Email: townsville@braziermotti.com.au Job No: 27001/118-01	PROJECT MANAGER	PROJECT DIRECTOR: D.GIBSON RPEQ 13230	Excellence Through Partnerships		A1 XREF

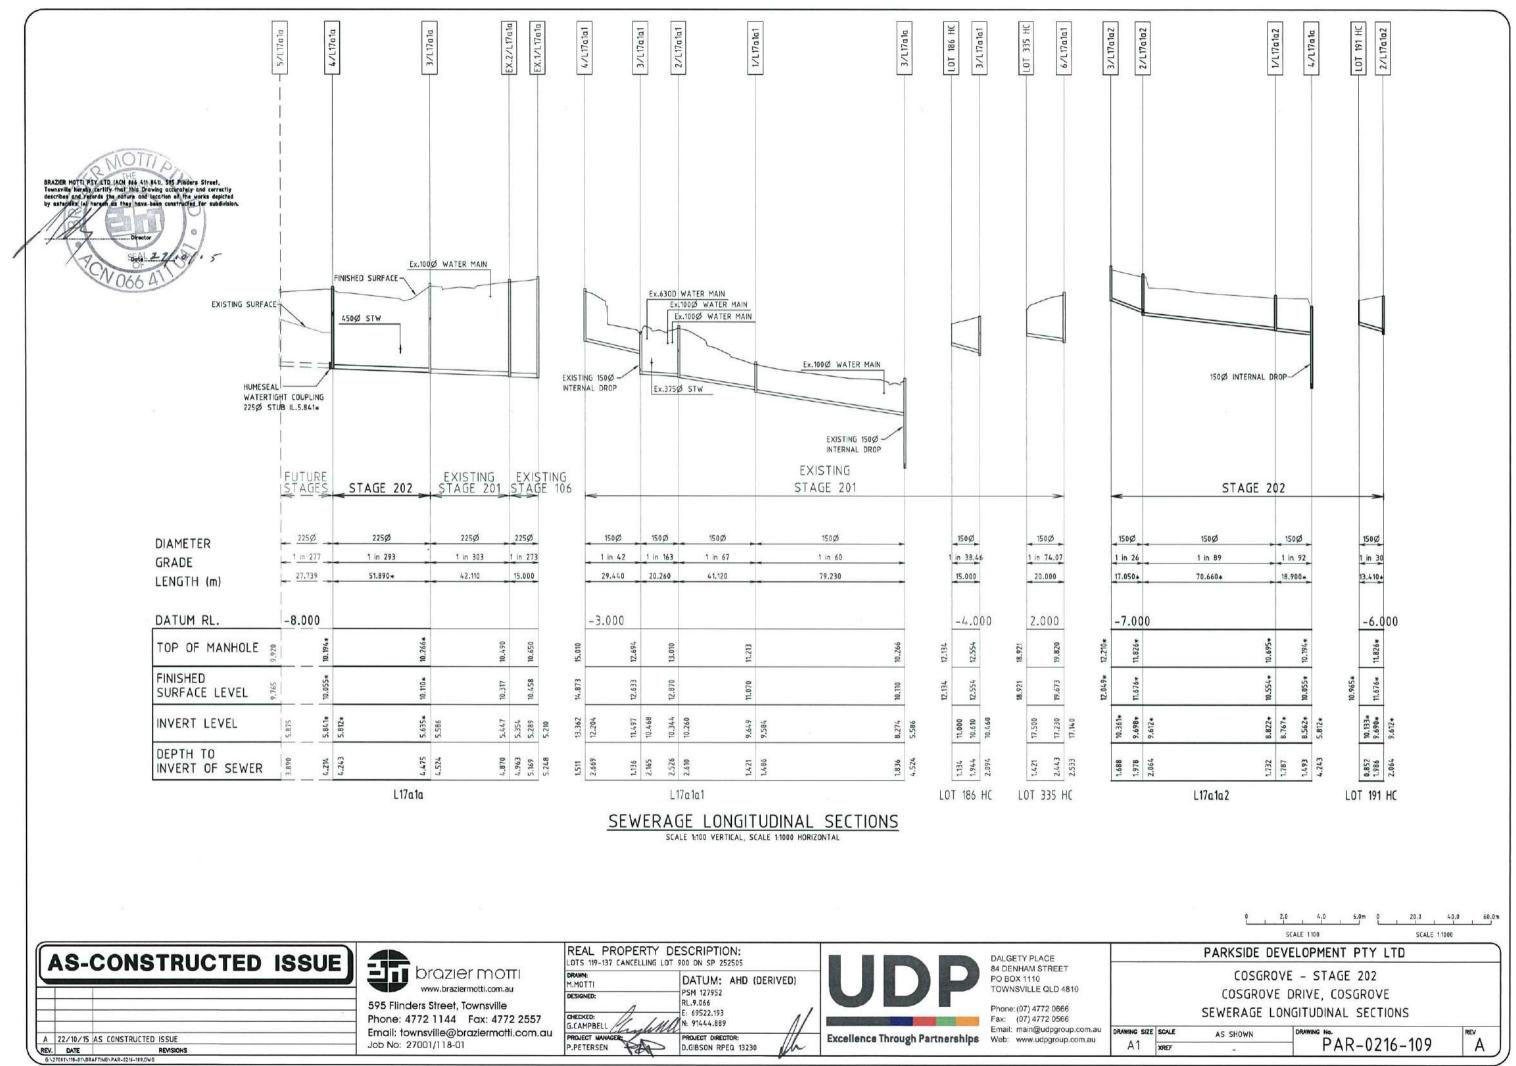


22/10/15	AS CONSTRUCTED ISSUE
DATE	REVISIONS

EAL PROPERTY DE TS 119-137 CANCELLING LOT			DALGETY PLACE 84 DENHAM STREET		_
ANN: MOTTI	DATUM: AHD (DERIVED)		PO BOX 1110 TOWNSVILLE QLD 4810		
SIGNED: ECKED: CAMPBELL	PSM 127952 RL.9.066 E: 69522.193 N: 91444.889		Phone: (07) 4772 0666 Fax: (07) 4772 0566 Email: main@udpgroup.com.au	DRAWING SIZE	
	PROJECT DIRECTOR: D.GIBSON RPEQ 13230	Excellence Through Partnerships	Web: www.udpgroup.com.au	A1	x
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- SUBSOIL DRAIN & CLEANOUT POINT




- 1. "SETBACK" MEANS A LINE OR LINES PARALLEL TO ANY BOUNDARY OF A LOT BEYOND WHICH THE BUILDING OR OTHER STRUCTURE SHALL NOT ENCROACH, AND MEASURED AS THE SHORTEST HORIZONTAL DISTANCE FROM THE OUTERMOST PROJECTION OF THE BUILDING OR OTHER STRUCTURE TO THE VERTICAL PROJECTION OF THE LOT
- BOUNDARY (TOWNSVILLE CITY PLAN 2005, PAGE 491). 2. THE BUILDING ENVELOPES ARE TO COMPLY WITH THE DESIGN CODE SHOWN ON THIS PLAN. GREATER SETBACKS MAY BE REQUIRED TO ACCOMMODATE THE ZONE OF INFLUENCE OF UNDERGROUND SERVICES AS STATED IN COUNCIL'S POLICY ON BUILDING OVER OR ADJACENT TO SEWERS.
- 3. DIMENSIONS SHOWN ARE QDC GROUND DWELLING ONLY AND DO NOT ACCOUNT FOR BATTERS OR RETAINING WALLS. A SITE INSPECTION IS REQUIRED PRIOR TO COMMENCEMENT OF DESIGN. REFER DESIGN CODE FOR UPPER FLOOR AND GARAGE SETBACKS.

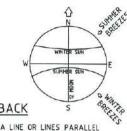ERGON SUBSTATIONS

1. HABITABLE ROOMS REQUIRE A CLEARANCE OF 4m TO ERGON SUBSTATION SITES.

CORNER SIGHT LINES

1. COMPLY WITH SIGHT LINES REQUIREMENT OF THE QUEENSLAND DEVELOPMENT CODE ON ROAD CORNERS. THIS IS TYPICALLY A 9m x 9m EXCLUSION ZONE BASED ON BOUNDARIES. FOR CLIPPED CORNERS AND LOTS WITH PARK FRONTAGES TYPICALLY THIS IS A 18m x 18m EXCLUSION ZONE BASED ON THE EDGE OF THE TRAFFIC LANE. REAR ACESS LANES ARE EXEMPTED FROM THIS REQUIREMENT.

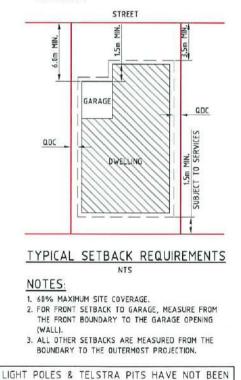

ON SITE. 5.0 10.0 15.0 m SCALE 1501 @ A3 PARKSIDE DEVELOPMENT PTY LTD COSGROVE - STAGE 202 COSGROVE DRIVE, COSGROVE BUILDING ENVELOPE & DRIVEWAY ACCESS PLAN PAR-0216-110 A PAR-0216-XR-ASCON

SHOWN AND LOCATION SHOULD BE CONFIRMED