

NOTES: • There are no existing or proposed

-drainage features

-retaining walls

-stormwater detention

-community purposes land

• Easements as shown

- The final intended use of all allotments is for residential except if otherwise marked purposes in accordance with Cosgrove Plan of
- There are no buildings or structures over the land relevant to this stage
- Access into each allotment shall be via the road frontage. Specific locations to be determined at time of detailed engineering design and preparation of access envelopes.

#### **DESIGN CODE - ALL ALLOTMENTS**

Туре	House, Front Loaded
Lot Access	Front
Lot Depth (Min)	25m (20m where 15m width proposed)
Lot Width (Min)	12.5
Site Coverage	May exceed 50% in response to Code
	Requirements, but no more than 60% Site Coverage.
Setback Front Ground (min) and upper (min)	3.5m
Setback Front Garage	6m and 1.5m behind front of dwelling
Setback Principal Side Ground (min)	QDC
Setback Principal Side Upper (min)	QDC
Setback Secondary Road Frontage (min)	QDC
Garage setback Secondary Road Frontage(min)	3.5m
Setback Principal Rear (min)	1.5m (*Sewer lines and manholes may enforce greater setbacks)
Outbuilding (Shed) Width (max)	Lesser of 50% of rear boundary or 9m
Outbuilding (Shed) Depth (max)	9m
Outbuilding (Shed) Rear Setback	0-1.0m
Outbuilding (Shed) Side Setback	Zero if lot 12.5m wide. As per Principal setback if lot >12.5m wide
Floor Height Principal (min)	400mm
Maximum Storeys	As per the Applicable Scheme
Private Open Space (min) (may be covered)	4mx4m
Parking (min)	Two (2), one of which must be covered
*Note: Clearances to sewer lines and manholes a	are required in accordance with council police

This plan is conceptual and for discussion purposes only. All areas, dimensions and land uses are preliminary, subject to investigation, survey, engineering, and Local Authority and Agency approvals.

#### **PROPOSED** RECONFIGURATION

Lots 277-283, 285, 287-290, 292-294, 297-304 and 900

Cancelling Lot 900 on SP306178

Parish of Coonambelah County of Elphinstone City of Townsville

#### **CORNER SIGHT LINES**

Comply with sight lines requirement of the Queensland Development code on road corners. This is typically a 9m x 9m exclusion zone based on boundaries.

For clipped corners, footpaths wider than 4.2m and lots with park frontages typically this is a 18m x 18m exclusion zone based on edge of traffic lane. Rear access lanes are exempted from this

**Townsville City Council** 

**Approved Subject to Conditions** 

RAL19/0062.03 28/10/2020





## **COSGROVE**

#### **STAGE 206**

Total Stage Area ...... 1.70ha Number of Lots ...... 23 Average Lot Area ...... 482m² Total Length of New Road .... 360m

**Build to Boundary Setback** 

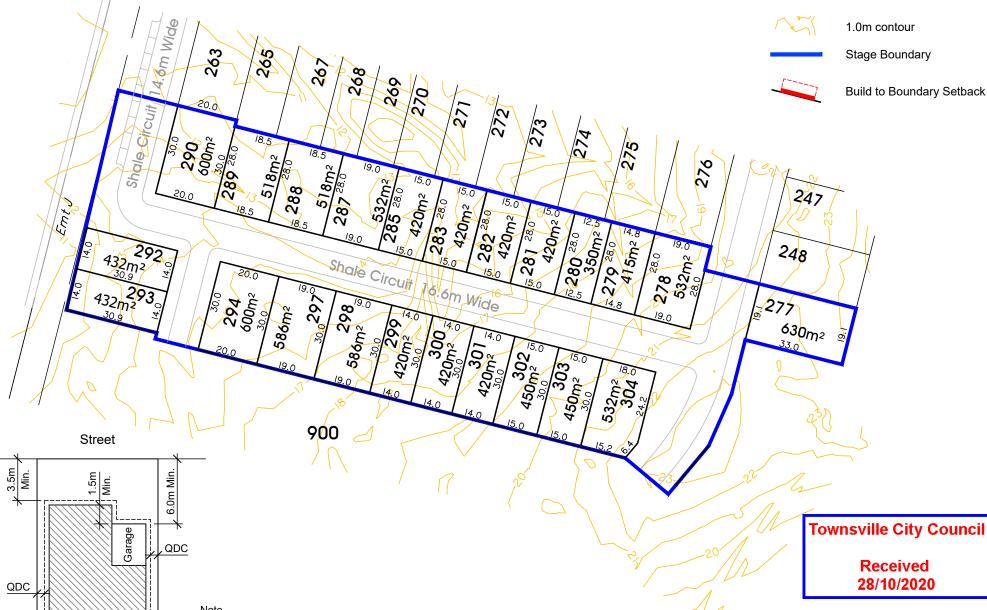

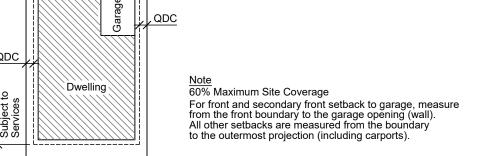

Typical Setback Requirements

Not to Scale

brazier moπi

P | 300 267 878 | Job No: 27001/152-1


Drawn: AJL

Date: 16th October, 2020


Scale: 1:1250 @ A3

www.braziermotti.com.au Plan No: 27001/107 K

surveying | town planning | project management | mapping and GIS

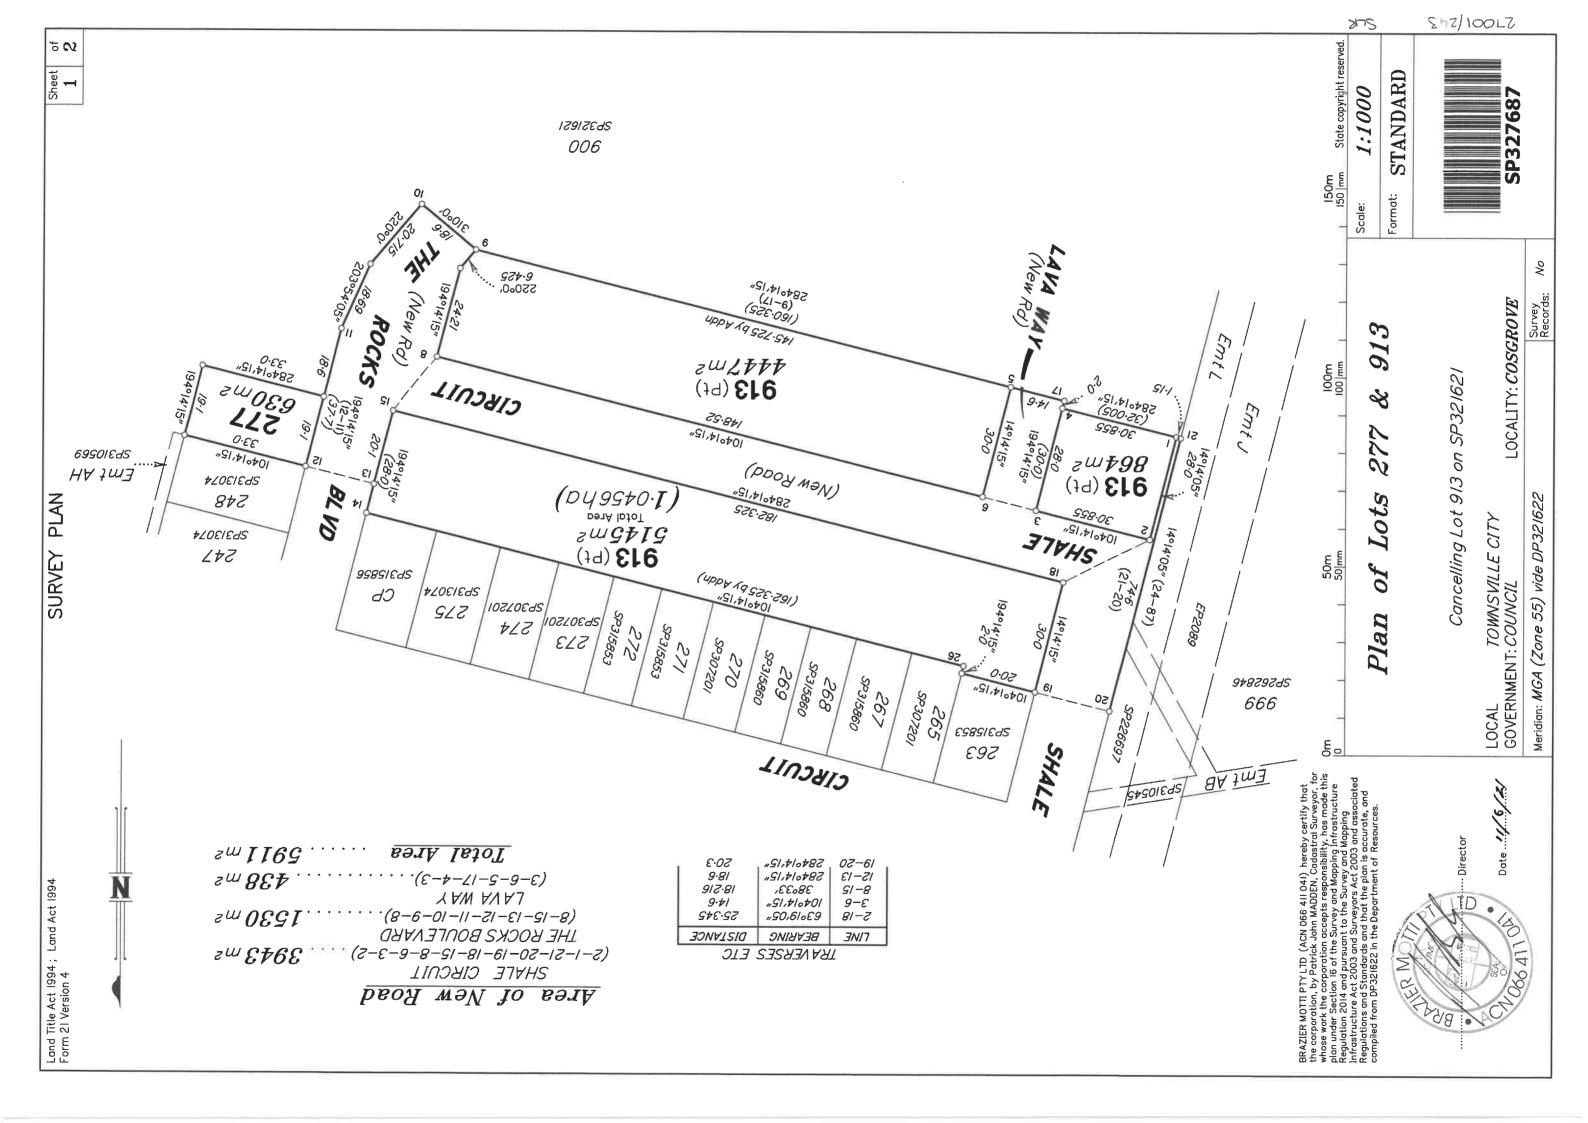

(Dealing No.)		kside	Development Pty Ctd	
		Hu St 2600 Laptolas a parkside Lodger Cale - 888 (Include address, phone number, email, reference, and Lodger Code)	biz.	
Existing			Created	
Title De Reference	Description	New Lots	Road   Secondary Interests	sts
			Building Format Plans only.  I certify that:  * As far as it is practical to deterraine, no part of the building shown on this plan encroaches onto adjoining lots or road:  * Part of the building-shown on this plan encroaches onto adjoining * lots and road  Cadastral Surveyor/Director*  Date	N
510 % 77C	109105 do 510 to 1		7. Lodgement Fees: Survey Deposit	J75
Lots			tles	5 17 3
Orig Grant Allocation :		5. Passed & Endorsed:	Photocopy \$	2/10
References:  Dept File:  Local Govt:  Surveyor: 27001/157-03 - 27001_243A.dwq	dwq - SLR - 06/2021	By: BRAZIER MOTTI PTY LTD  Date: "KA"  Signed: Indison Officer  Designation:	SP3276	210

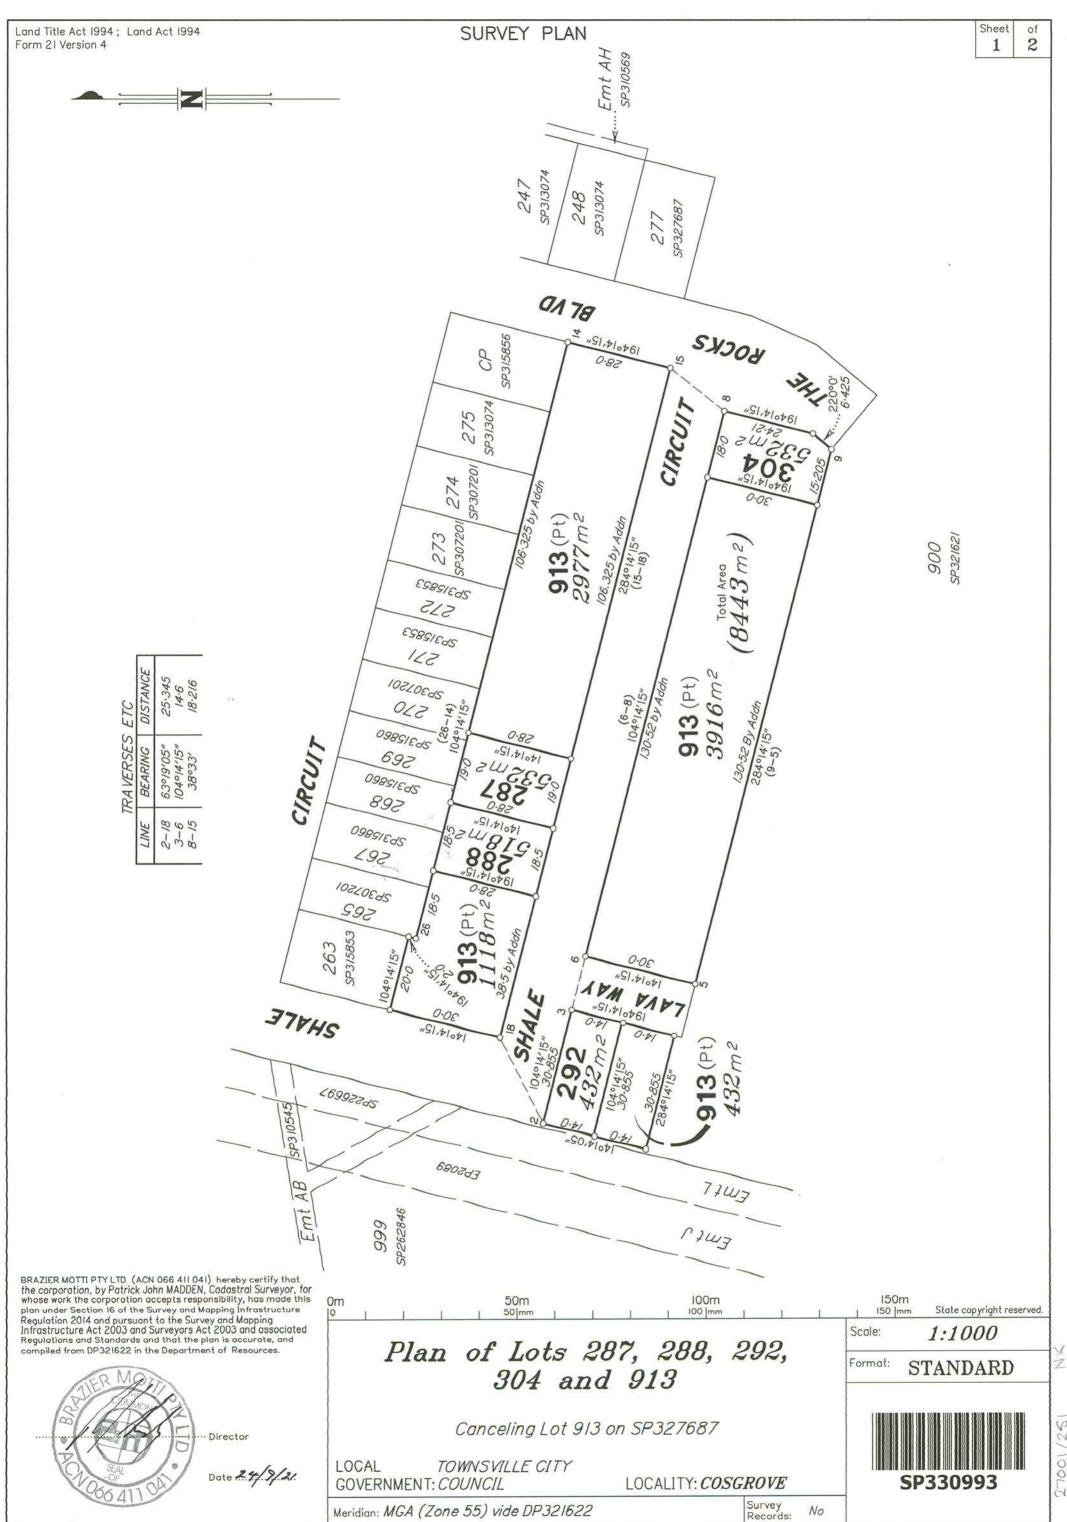

nd Title Act 1994; Land A rm 21B Version 2	ct 1994		WARNING: Folded or Mutilated Plans will not be accepted. Plans may be rolled.  Information may not be placed in the outer margins.				
	(Dealing	No.)	4. Lodged by				
			(Include address, phone number, email, reference, and Lodger Code)				
Title	Existin			eated		9.31	
Reference 51260805	Lo	Description t 913 on SP327687	New Lots 287, 288, 292, 304 & 913	h	Road Secondary	Interes	
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		\$1					
				I certify that:  * As far as it is p of the building sh onto adjoining lot  * Part of the buil	ractical to determine own on this plan enci s or road, ding shown on this pl adjoining * lots and r	e, no pa roaches	
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287, 288, 292 Lot		Lot 913 on SP321621 Orig		Lodgement New Title	•		
		V.19	5. Passed & Endorsed :	Photocopy	*		
Jrig Grant Allocat			J. 1 43364 & LITUOI 364.	0 1	dt		
18			By: BRAZIER MOTTI DTV LTD	Postage			
Orig Grant Allocat References : Dept File : Local Govt :			By: BRAZIER MOTTI PTY LTD  Date: 24/9/2/	TOTAL	\$		

\*

TRAVERSES ETC

LINE BEARING DISTANCE 63°19'05" 104°14'15" 38°33' 2-18 3-6 8-15 25·345 14·6 18-216

CIRCUIT

268

269

913 (Pt)

270 59307201

523/5853 2/1/2

6.283 420m26

104014'15"

19401415"

\$ 272 \$P3/5853

273

SP307201

913 (Pt)

42.5 by oddn

274

SP30720

275

SP313074

14.826

CIRCUIT

194%

279 (15m² s

CP

SP315856

278 532m2

0178

194014'15"

POCKS

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Plan 290, of Lots

Cancelling Lot 913 on SP330993

LOCALITY: COSGROVE

Survey Records: **⊘** 

Meridian: MGA (Zone 55) Vide DP321622

LOCAL TOWNSVILLE CITY
GOVERNMENT: COUNCIL

278, 302,

289,

Format:

WCHO

293, 279, 303

283,

80 913

293<sup>30.85</sup> Emt Emtl

100-52 by addn 913 (Pt) 3016 m²

265

289 518m2

267

194°14"15" 288

263

SP315853

104014'15"

600me

290

SHALE 30.855

292 Sp330993

104014'15"

SHALE

ISP310545

Emt AB

999

SP262846

 $(4626\,$ m $^2)$ 

SOS 15.0

900 SP321621

1:1000

Scale:

STANDARD

27001/252

SP331011

₩₫

Local Govt : Surveyor: 27001/157-03 - 27001_252A.dwg - WCHO - 10/2021	<ol> <li>References:</li> <li>Dept File:</li> </ol>	2. Orig Grant Allocation :		278, 279, 283, 289, 290, 293, 302, 303 & 913 Lot 913 on SP321621	Lot 913 on SP330993	Reference Description	I. Existing		Form 2IB Version 2  (Dealing No.)
ation: Liaison Officer	By: BRAZIER MOTTI PTY LTD  Date: 6/9/4	5. Passed & Endorsed:			278, 279, 283, 289, 290, 293, 302, 303 & 913		Created	(Include address, phone number, email, reference, and Lodger Code)	WARNING: Folded or Mutilated Plans will Plans may be rolled. Information may not be placed in the 4. Lodged by
8. Insert Plan SP331011		Photocopy \$	ties \$	Survey Deposit \$	& 913	Road Secondary Interests	ted	d Lodger Code)	lans will not be accepted. 2 2 rolled.  In the outer margins.

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TRAVERSES ETC

1.	RAVERSES	E / C
LINE	BEARING	DISTANCE
2-18 3-6 8-15	63°19′05″ 104°14′15″ 38°33′	25·345  4·6  8·2 6

SHALE TSP310545 CIRCUIT Emt AB 263 265 SP315853 267 268 999 269 SP3/5860 270 SP30720/ SP262846 SP3/5853 1/2 \$272 \$23/5853 | 273 |SP307201| 290 SP331011 EP2089 274 289 SP33/0// (26-14) 104°14′15″ 275 288 SP330993 <sup>|</sup>SP307201 287 58330893 14°14′15″ 15.0 CPSP3/3074 285 420m2 SHALE 30.855 SP315856 (76.0 by Addn) 280 28.0 350m 230 0178 4281 4202 292 SP330993 284°|4′|5" (15-18) WAY 294 600m2 293 (6-8) 104°14′15″ (33.825 by Addn) SP331011 EmtJ 4414 297 586m2 EmtL CIRCUIT 298 570m2 POCKS 299 30.0 420m. (48.0 by Addn) 301 300 420m2 300 SP331011 302 303 304

> 900 SP321621

0 M

LOCAL TOWNSVILLE CITY
GOVERNMENT: COUNCIL

285,

294,

and

297-301

Plan

of

Lots

280-282,

13-01-22

Meridian: MGA (Zone 55) Vide DP321622

Cancelling Lot 913 on SP331011

 $\stackrel{>}{\sim}$ 

LOCALITY: COSGROVE

Format: Scale:


STANDARD 1:1000



d Title Act 1994; Lanc n 21B Version 2	J ACT 1994		WARNING: Folded or Mutilated Plans will not be accepted. Plans may be rolled.  Information may not be placed in the outer margins.			
	(Dealii	ng No.)	4. Lodged by	6		
			(Include address, phone number, email, referenc	e, and Lodger Code)		
	Exis	ting		Created		
Title Reference		Description	New Lots	Road Secondary Interest		
51266721		Lot 913 on SP331011	280-282, 285, 294, 297-3	301 —— ——		
				6. Building Format Plans only.  I certify that:  * As far as it is practical to determine, no par of the building shown on this plan encroaches onto adjoining lots or road;  * Part of the building shown on this plan encroaches onto adjoining * lots and road		
				Cadastral Surveyor/Director* Date #delete words not required		
	ı			7. Lodgement Fees :		
200 05-	5 00 / 05 = 5			Survey Deposit \$		
	5, 294, 297-301 Lots	Lot 913 on SP321621		Lodgement \$New Titles \$		
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rig Grant Alloc	auon.		5. Passed & Endorsed :	Postage \$		
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# **COSGROVE - STAGE 206** COSGROVE DRIVE, COSGROVE FOR PARKSIDE DEVELOPMENT PTY LTD



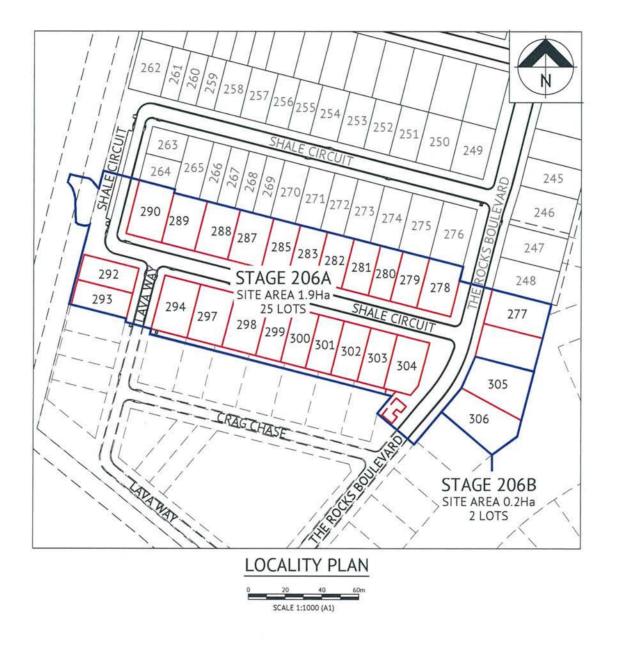

Sheet List Table							
Sheet Number	Sheet Title						
27001/217	COVER SHEET LOCALITY PLAN & DRAWING SCHEDULE						
27002/218	EARTHWORKS LAYOUT PLAN						
27003/219	ROADWORKS AND STORMWATER DRAINAGE PLAN						
27004/220	THE ROCKS BOULEVARD AND LAVA WAY LONGITUDINAL SECTION						
27005/221	THE ROCKS BOULEVARD AND LAVA WAY CROSS SECTIONS						
27006/222	SHALE CIRCUIT LONGITUDINAL AND CROSS SECTIONS						
27007/223	ROADWORKS DETAILS PLAN						
27008/224	Q2 STORMWATER LONGITUDINAL SECTION						
27009/225	WATER RETICULATION PLAN						
27010/226	SEWERAGE RETICULATION PLAN						
27011/227	SEWERAGE LONGITUDINAL SECTIONS						
27012/228	RETAINING WALL DETAILS						

MENDI CONSTRUCTIONS PTY LTD DO HEREBY CERTIFY THAT THE WORKS SHOWN ON THE 'AS CONSTRUCTED' DRAWINGS HAVE BEEN CONSTRUCTED IN ACCORDANCE WITH THE DRAWINGS AND CONTRACT DOCUMENTS APPROVED BY COUNCIL FOR THE CONSTRUCTION OF THE PROJECT.

DATE 19/4/21

PREMISE DO HEREBY CERTIFY THAT THE WORKS AS SHOWN ON THE 'AS CONSTRUCTED' DRAWINGS REFLECT ANY CHANGES THAT WERE MADE DURING THE COURSE OF CONSTRUCTION.

FA 13 231 DATE 19.4.21

				Level Datum: AHD (DENIVED)		
No.	Date	Details	Check	B.M. Used: PM204181 Rt:10.188		
A	12.04.21	Original Issue	GEO	Coordinate Projection: Plane Rectang	ular	
				Coordinate Datum: Arbitrary		
	-			Origin of Coordinates: PM204181	€:	69029,701
				Meridian: MGA94 (Zone 55)	N:	90844,196
				Map Reference:		
				Contour Interval:	Sur	veyed by: BM
				Job No: 27001-158-01	Dra	wn: MIM
				File Noc 27001_217A.dwg	App	roved:

PARKSIDE DEVELOPMENT PTY LTD

**COSGROVE STAGE 206** COSGROVE DRIVE, COSGROVE


LOCALITY PLAN, SITE PLAN & DRAWING SCHEDULE Local Authority: Townsville City Council




Scale: AS SHOWN




Plan No: 27001/217 A

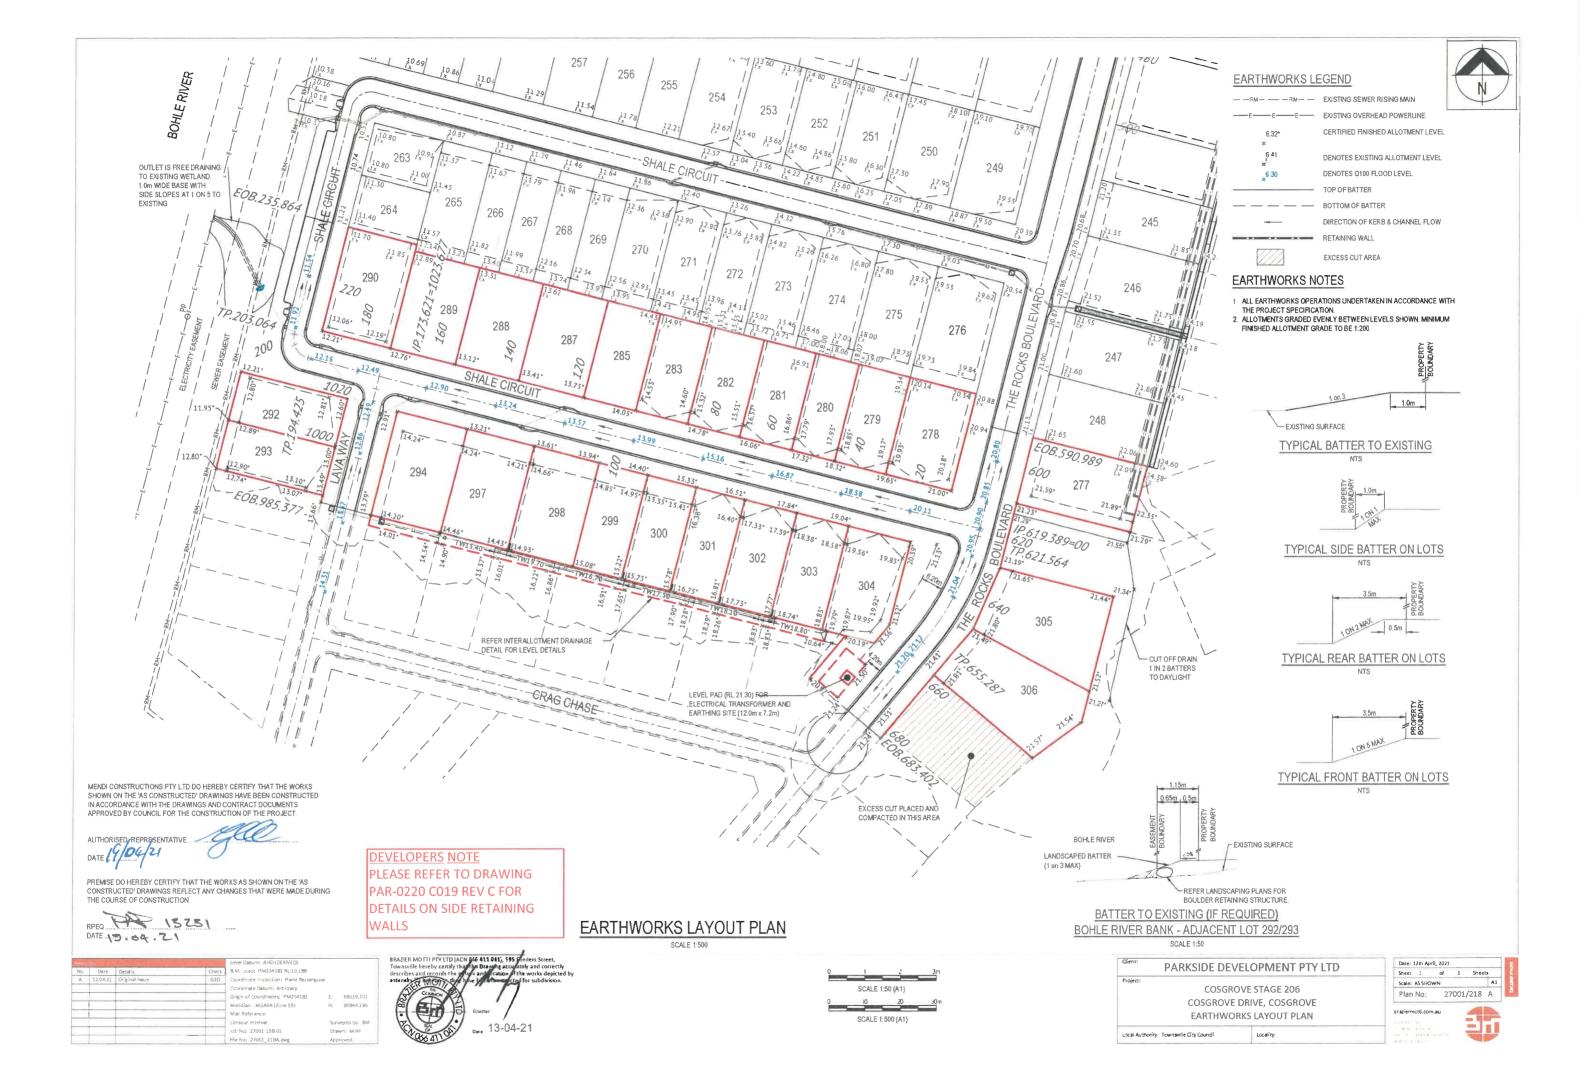

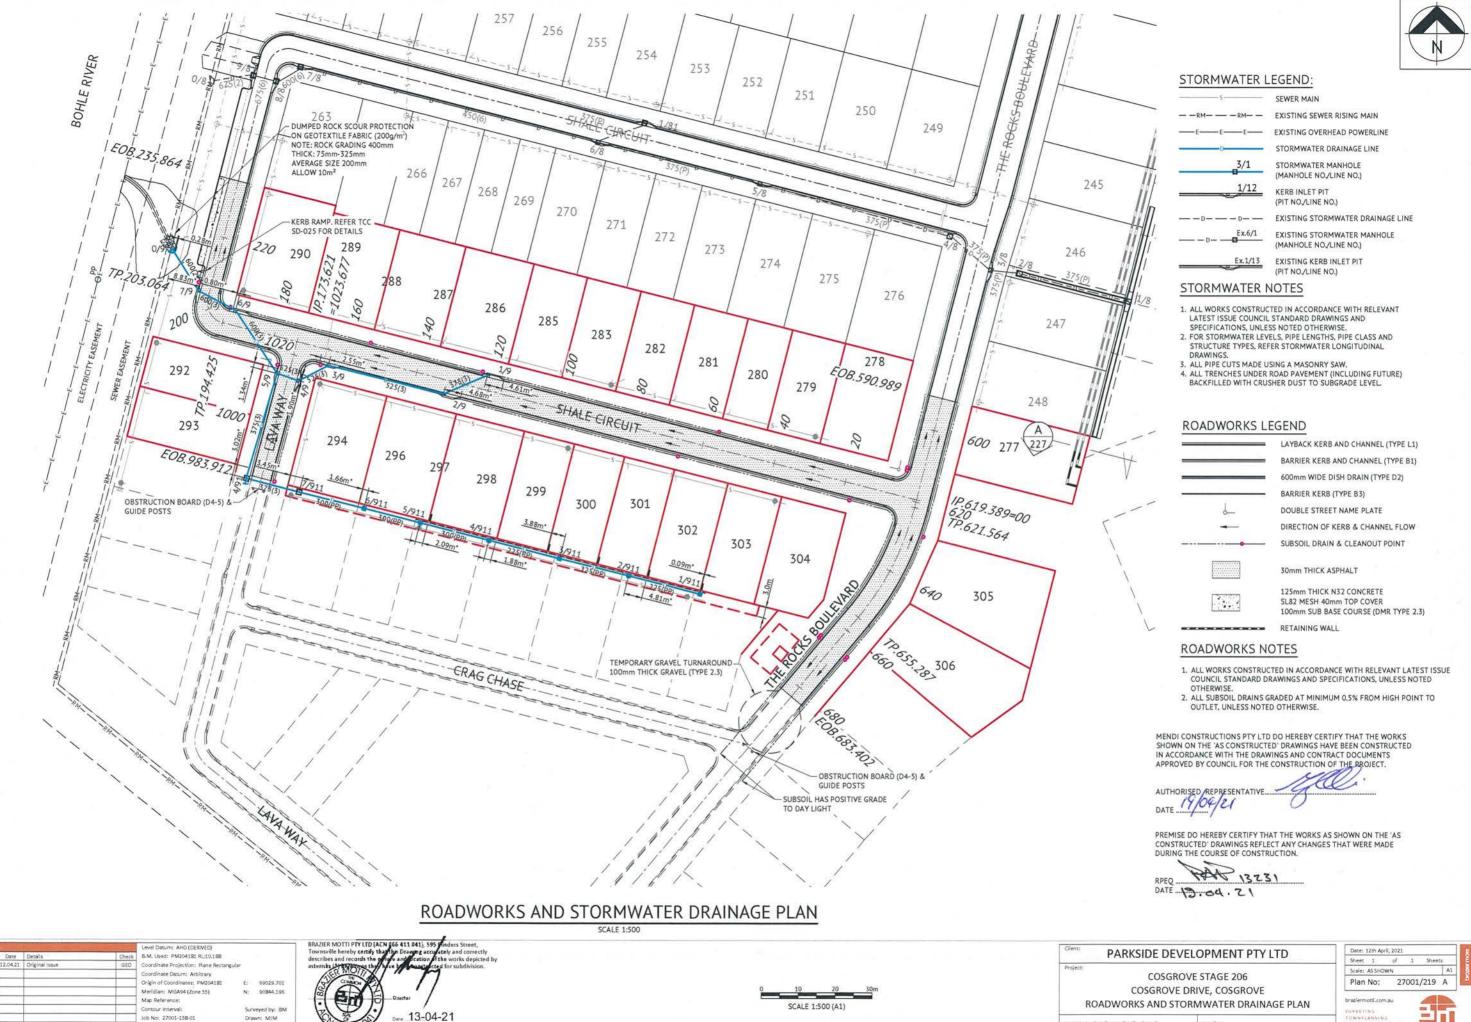


Local Authority: Townsville City Cound

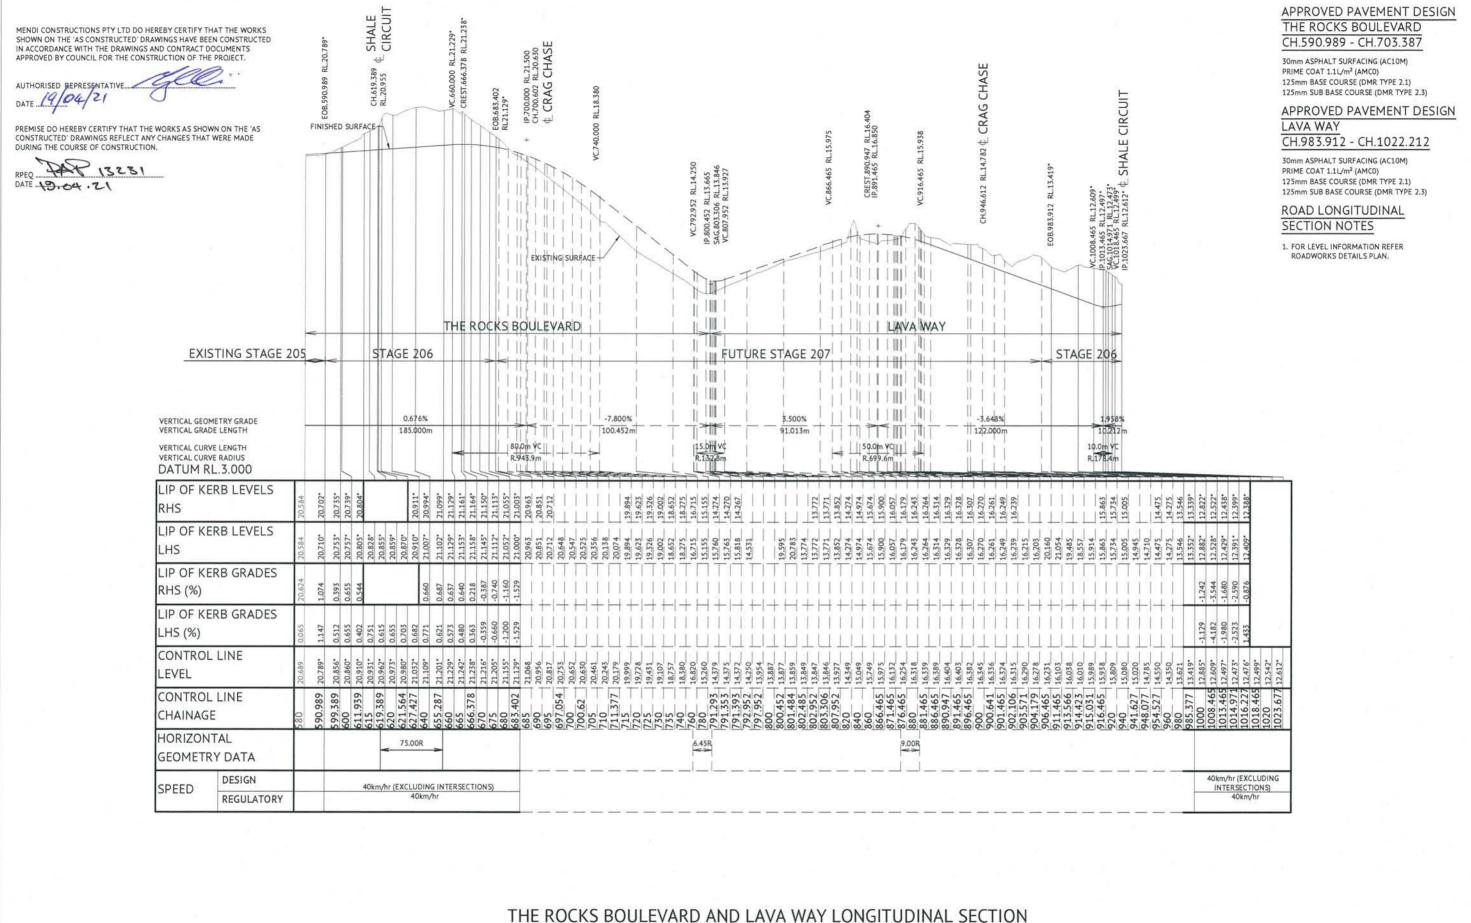

### SCALE 1:1000 HORIZONTAL, SCALE 1:100 VERTICAL

B.M. Used: PM204181 RL:10.188 Coordinate Projection: Plane Recta oordinate Datum: Arbitrary Origin of Coordinates: PM204181 Meridian: MGA94 (Zone 55) Map Reference: Contour interval: Job No: 27001-158-0 File No: 27001\_220A.dw



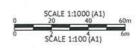

#### PARKSIDE DEVELOPMENT PTY LTD


**COSGROVE STAGE 206** COSGROVE DRIVE, COSGROVE THE ROCKS BOULEVARD AND LAVA WAY LONG SECTION

Local Authority: Townsville City Council Locality:


Scale: AS SHOWN 27001/220 A Plan No:






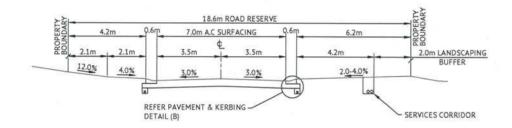

#### THE ROCKS BOULEVARD CROSS SECTIONS

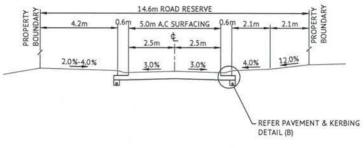


### LAVA WAY CROSS SECTIONS

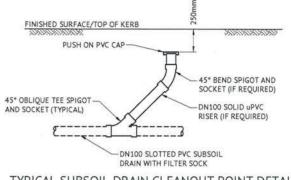


#### TYPICAL SUBSOIL DRAIN CLEANOUT POINT DETAIL

NOTE: PROVIDE "S" BRASS KERB MARKER TO INDICATE LOCATION OF CLEANOUT POINT

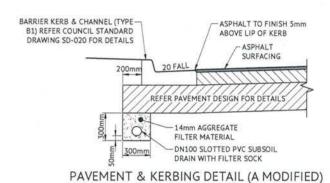

SCALE 1:20

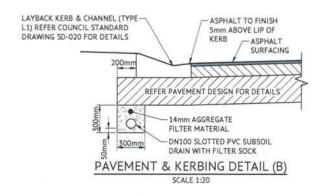


MENDI CONSTRUCTIONS PTY LTD DO HEREBY CERTIFY THAT THE WORKS SHOWN ON THE 'AS CONSTRUCTED' DRAWINGS HAVE BEEN CONSTRUCTED IN ACCORDANCE WITH THE DRAWINGS AND CONTRACT DOCUMENTS APPROVED BY COUNCIL FOR THE CONSTRUCTION OF THE PROJECT.

DATE 19/04/21

PREMISE DO HEREBY CERTIFY THAT THE WORKS AS SHOWN ON THE 'AS CONSTRUCTED' DRAWINGS REFLECT ANY CHANGES THAT WERE MADE DURING THE COURSE OF CONSTRUCTION.

FAP 13231 DATE S.OQ.21

1545,6				Level Datum: AHD (DERIVED)		
No.	Date	Details	Check	8.M. Used: PM204181 RL:10.188		
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				Coordinate Datum: Arbitrary		
				Origin of Coordinates: PM204181	£	69029,701
				Meridian: MGA94 (Zone 55)	N:	90844.196
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				File No: 27001_221A.dwg	App	roved:

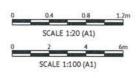

PARKSIDE	DEVEL	OPM	FNT	PTV	ITL


COSGROVE STAGE 206 COSGROVE DRIVE, COSGROVE THE ROCKS BOULEVARD AND LAVA WAY CROSS SECTIONS

Locality:

Local Authority: Townsville City Council

Date: 12th April, 2021 Sheet 1 of 1 Scale: AS SHOWN



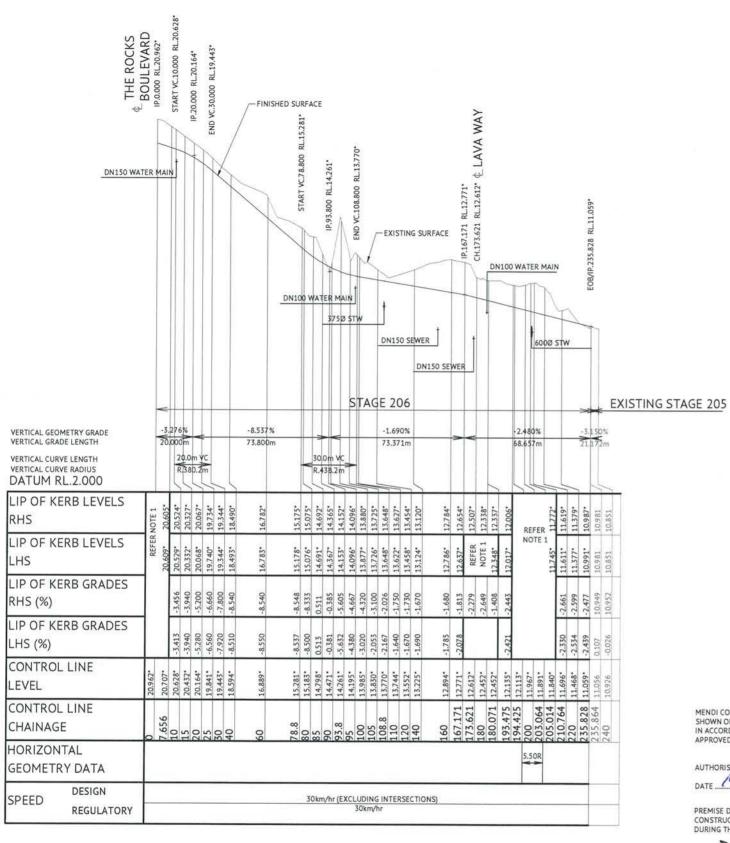

#### SHALE CIRCUIT LONGITUDINAL SECTION

SCALE 1:1000 HORIZONTAL, SCALE 1:100 VERTICAL


APPROVED PAVEMENT DESIGN SHALE CIRCUIT

CH.0.000 - CH.235.864

30mm ASPHALT SURFACING (AC10M)
PRIME COAT 1.1L/m² (AMC0)
125mm BASE COURSE (DMR TYPE 2.1)
125mm SUB BASE COURSE (DMR TYPE 2.3)

### ROAD LONGITUDINAL SECTION NOTES

FOR LEVEL INFORMATION REFER
 ROADWORKS DETAILS PLAN.

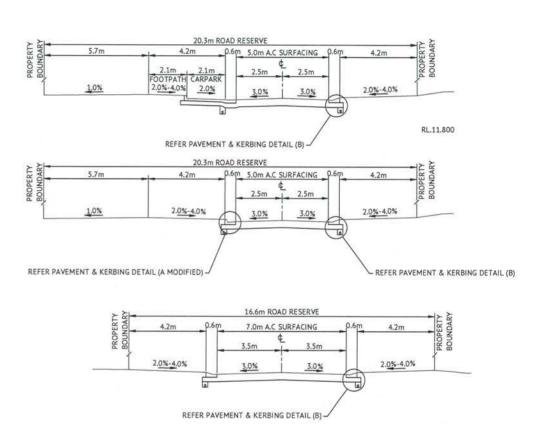

MENDI CONSTRUCTIONS PTY LTD DO HEREBY CERTIFY THAT THE WORKS SHOWN ON THE 'AS CONSTRUCTED' DRAWINGS HAVE BEEN CONSTRUCTED IN ACCORDANCE WITH THE DRAWINGS AND CONTRACT DOCUMENTS APPROVED BY COUNCIL FOR THE CONSTRUCTION OF THE PROJECT.

AUTHORISED REPRESENTATIVE

DATE 19/04/21

PREMISE DO HEREBY CERTIFY THAT THE WORKS AS SHOWN ON THE 'AS CONSTRUCTED' DRAWINGS REFLECT ANY CHANGES THAT WERE MADE DURING THE COURSE OF CONSTRUCTION.

PPEQ 13251

#### SHALE CIRCUIT CROSS SECTIONS

SCALE 1:100

-	111			Level Datum: AHD (DERIVED)		
No.	Date	Details	Check	B.M. Used: PM204181 Rt:10.188		
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				Origin of Coordinates: PM204181	E:	59029,701
				Meridian: MGA94 (Zone 55)	N:	90844,196
				Map Reference:		
				Contour Interval:	Sun	veyed by: BN
				Job No: 27001-158-01	Dra	wa: MIM
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BRAZIER MOTTI PTY LTD IACN 866 411 041), 595 Enders Street,
Townsville hereby certify that the Drawing accustably and correctly
describes and records the allust and fixation of the works depicted by
asterisks. The property of the works depicted by
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#### PARKSIDE DEVELOPMENT PTY LTD

COSGROVE STAGE 206
COSGROVE DRIVE, COSGROVE

SHALE CIRCUIT LONGITUDINAL AND CROSS SECTIONS

Local Authorby: Townsville City Council

Local Fly:

PROJECT MANAGEMENT

Plan No:

Date: 12th April, 2021



MENDI CONSTRUCTIONS PTY LTD DO HEREBY CERTIFY THAT THE WORKS SHOWN ON THE 'AS CONSTRUCTED' DRAWINGS HAVE BEEN CONSTRUCTED IN ACCORDANCE WITH THE DRAWINGS AND CONTRACT DOCUMENTS APPROVED BY COUNCIL FOR THE CONSTRUCTION OF THE PROJECT. DATE 19/04/21 BARRIER KERB PROFILE TYPE -PREMISE DO HEREBY CERTIFY THAT THE WORKS AS SHOWN ON THE 'AS 2.1m CARPARK INVERT PROFILE SIMILAR TO DISH CONSTRUCTED' DRAWINGS REFLECT ANY CHANGES THAT WERE MADE DURING THE COURSE OF CONSTRUCTION. **B3. POUR MONOLITHICALLY** WITH CARPARK. DRAIN TYPE D2. POUR MONOLITHICALLY WITH CARPARK. 3.0% 2.0% 125mm THICK N32 CONCRETE — SL82 MESH 40 TOP COVER E08.235.864 MINIMUM 150mm SUBBASE 100mm SUBBASE COURSE (DMR TYPE 2.3) COURSE TYPE 2.3 BELOW INVERT SECTION A - CARPARK BAYS ROADWORKS DETAILS LEGEND E LAYBACK KERB & CHANNEL (TYPE L1) BARRIER KERB & CHANNEL (TYPE B1) BARRIER KERB (TYPE B3) SAWCUT JOINT 5mm WIDE PROVIDE POLYURETHANE BASED SEALANT TO JOINT (20mm DEEP) 220 **ROADWORKS DETAILS NOTES** 290 1. ALL WORKS CONSTRUCTED IN ACCORDANCE WITH RELEVANT LATEST ISSUE COUNCIL STANDARD DRAWINGS AND SPECIFICATIONS, UNLESS NOTED OTHERWISE. 2. ALL RADII AND LEVEL INFORMATION IS TO LIP OF KERB 289 UNLESS NOTED OTHERWISE. KTPL.210.764 KTP.205.014 11.74 MESH-LOCALLY DEPRESS BELOW SAWCUT & CUT EVERY SECOND BAR SAW CUT JOINT (SJ) 11.776 SCALE 1:10 NOTE: MAXIMUM JOINT SPACING 6.0m. 11.80 T = SLAB THICKNESS 200 11.849 600 278 SHALE CIRCUIT \_R3.95m THE ROCKS BOULEVARD 277 195m 12612. ¥12.771. R\* GALVANISED DOWEL BARS 450 LONG
 @ 300CRS, PLACED CENTRALLY ON SPECIAL SHALE CIRCUIT KTPR.611.939 \$ 1020 × 10mm THICK COMPRESSIBLE FILLER BOARD BAR SUPPORT CHAIRS. GREASED ONE END. FOR FULL DEPTH OF SLAB, POLYURETHANE DOWEL BARS MUST BE STRAIGHT WITH SAWN ENDS, (NOT SHEARED), PLACED HORIZONTALLY AND PARALLEL 292 r R3.95m 3.029% IP.619.389=00 LAVA WAY TP.621.564 294 CONTRACTION JOINT (CJ) SCALE 1:10 KTPR.627.427-NOTE: MAXIMUM JOINT SPACING 15.0m R\* = R16 FOR SLAB THICKNESS (100mm-150mm) R\* = R20 FOR SLAB THICKNESS (151mm-190mm) R\* = R24 FOR SLAB THICKNESS (191mm-240mm) ROADWORKS DETAILS SCALE 1:10 (A1) SCALE 1:25 (A1) SCALE 1:200 (A1) Date: 12th April, 2021 PARKSIDE DEVELOPMENT PTY LTD **COSGROVE STAGE 206** Plan No: 27001/223 A COSGROVE DRIVE, COSGROVE

No.	Date	Details	Check	B.M. Used: PM204181 RL:10.188		
A	12.04.21	Original Issue	GEO	Coordinate Projection: Plane Rectang	ulac	
				Coordinate Datum: Arbitrary		
				Origin of Coordinates: PM204181	Ε:	69029.701
				Meridian: MGA94 (Zone 55)	N:	90844.196
				Map Reference:		
				Contour Interval:	Sur	veyed by: BM
				Job Not 27001-158-01	Dra	wit: MiM
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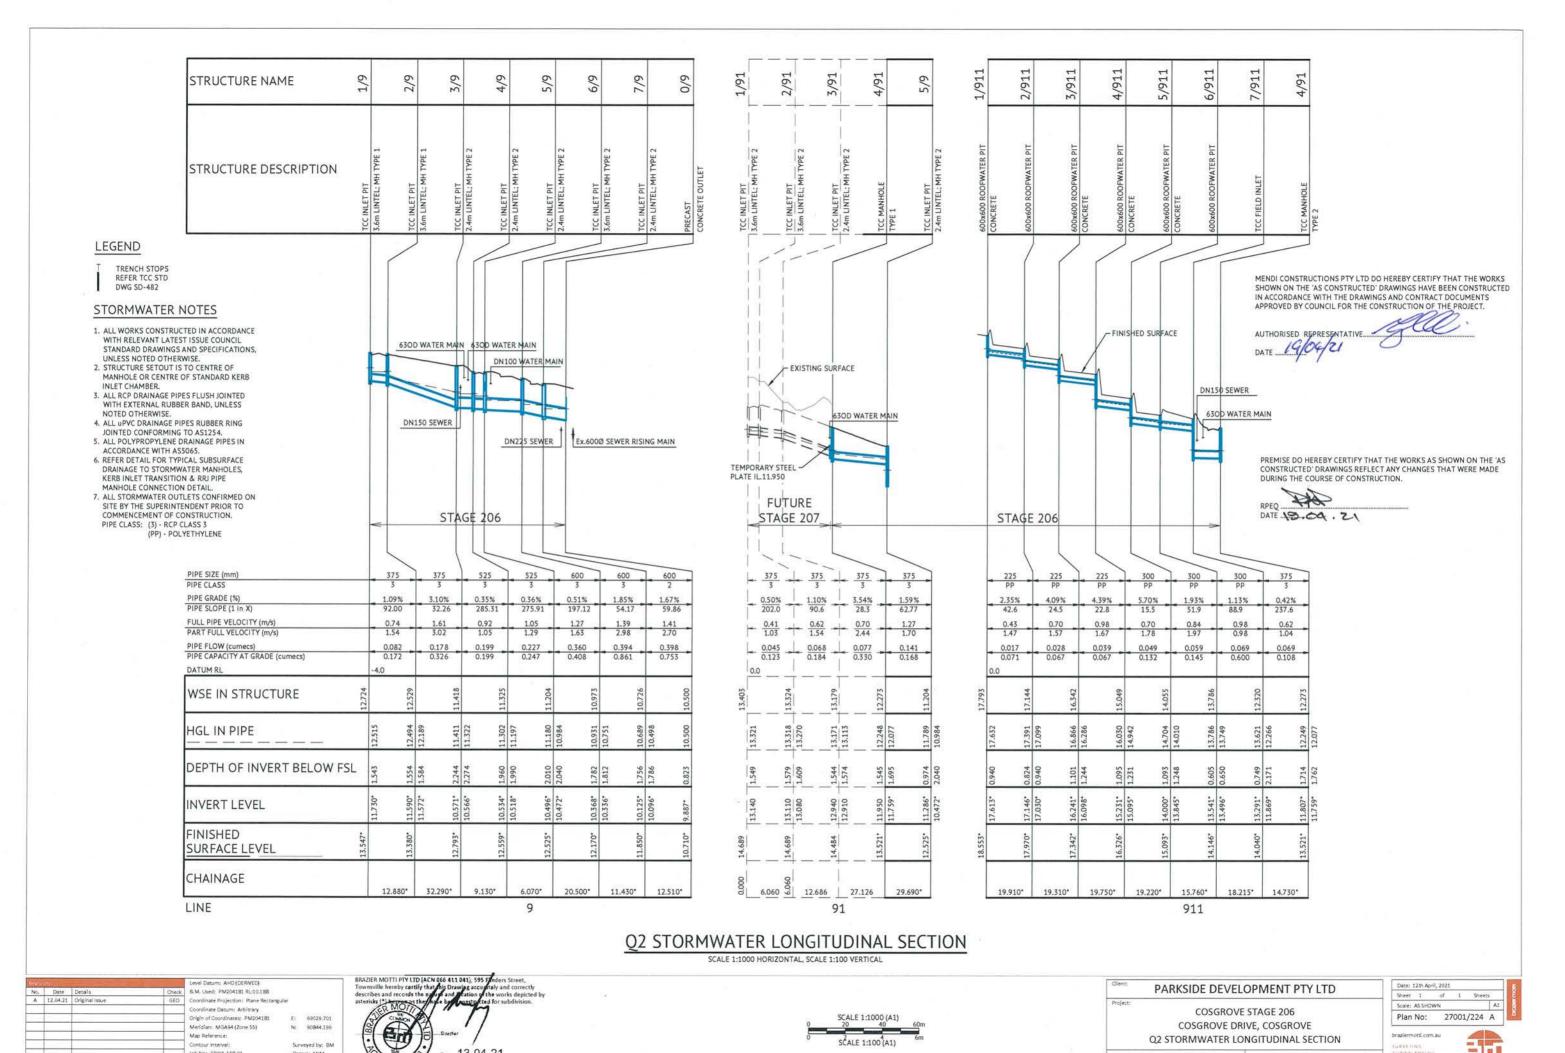


**ROADWORKS DETAILS PLAN** 









File No: 27001\_224A.dwg

Local Authority: Townsville City Council

Locality:



SCALE 1:500 (A1)

Meridian: MGA94 (Zone 55)

Contour Interval


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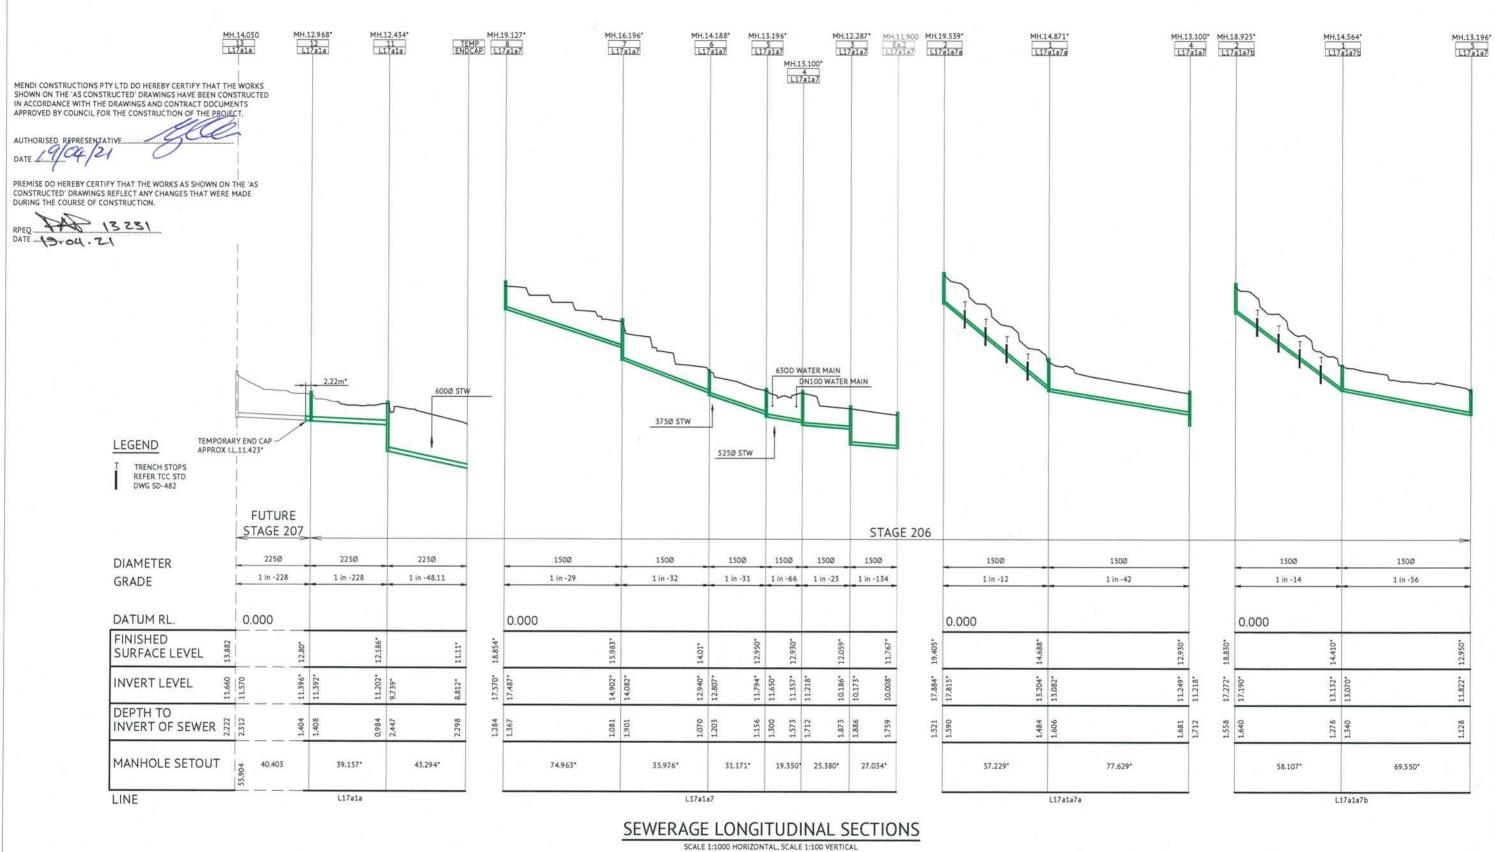
N: 90844,196

13-04-21

COSGROVE DRIVE, COSGROVE WATER RETICULATION PLAN

Local Authority: Townsville City Council



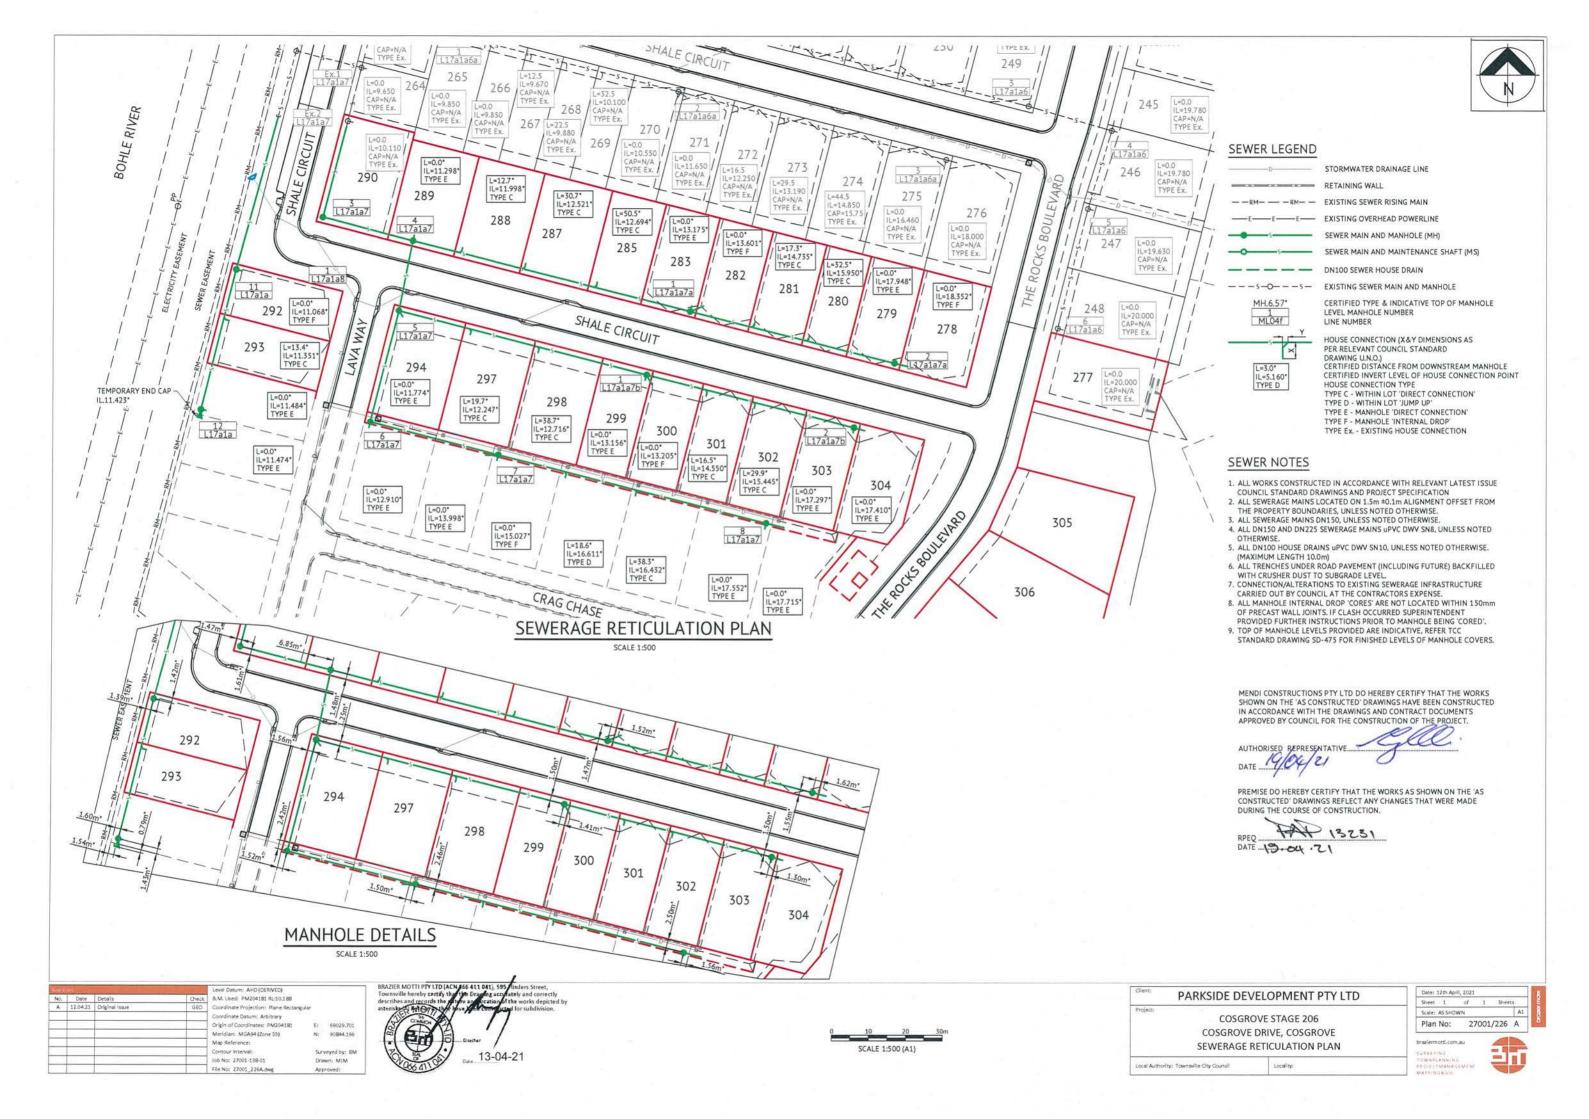

OCCUPATION OF THE PARTY OF THE			Level Datum: AHD (DERIVED)			
No.	Date	Details	Check	8.M. Used: PM204181 RL:10.188		
A	12.04.21	Original Issue	GEO	Coordinate Projection: Plane Rectang	ular	
				Coordinate Datum: Arbitrary		
				Origin of Coordinates: PM204181	E:	69029,701
				Meridian: MGA94 (Zone 55)	N:	90844.195
				Map Reference:		
	S			Contour interval:	Sun	veyed by: BN
				Job Not 27001-158-01	Dra	wn; MIM
				The same against a same of		




### PARKSIDE DEVELOPMENT PTY LTD


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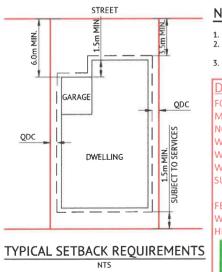
**COSGROVE STAGE 206** COSGROVE DRIVE, COSGROVE

SEWERAGE LUNGITUDINAL PLAN							
ty: Townsville City Cound!	Locality:						

Date: 12th Apr	1, 2021	-			
Sheet 1	of	1	Shee	ts .	
Scale: AS SHOWN A1					
Plan No:	27	7001	/227	Α	



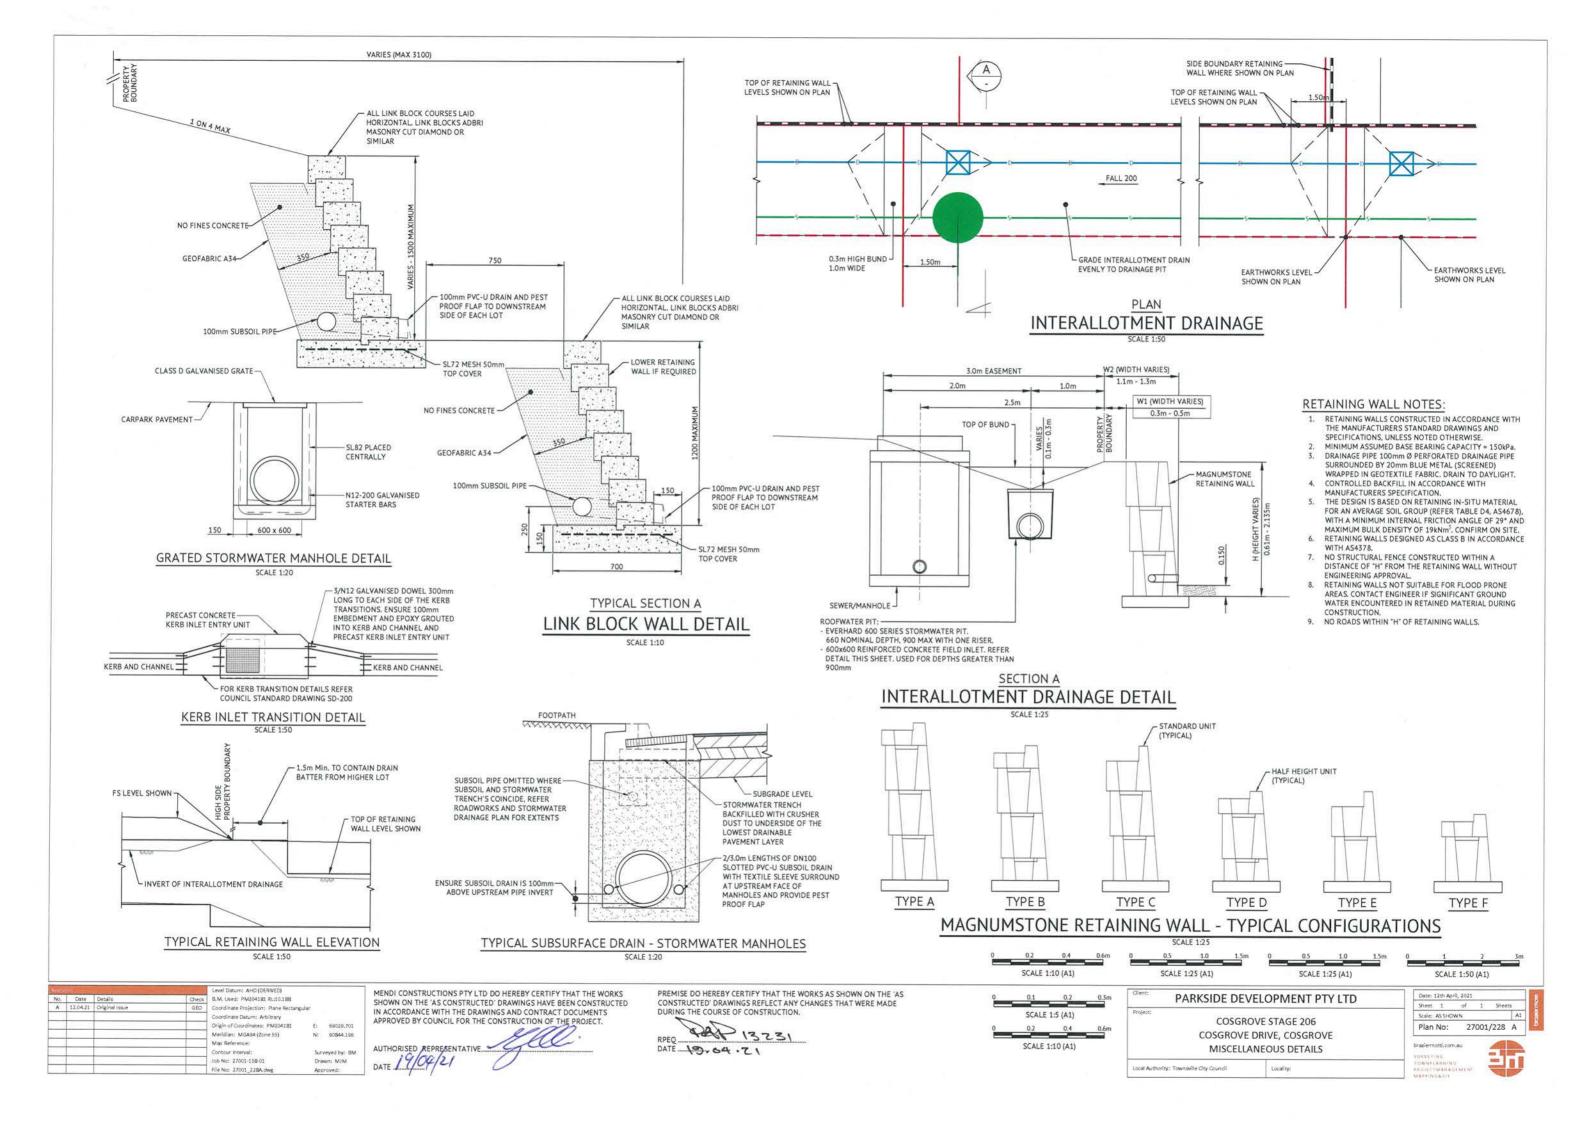

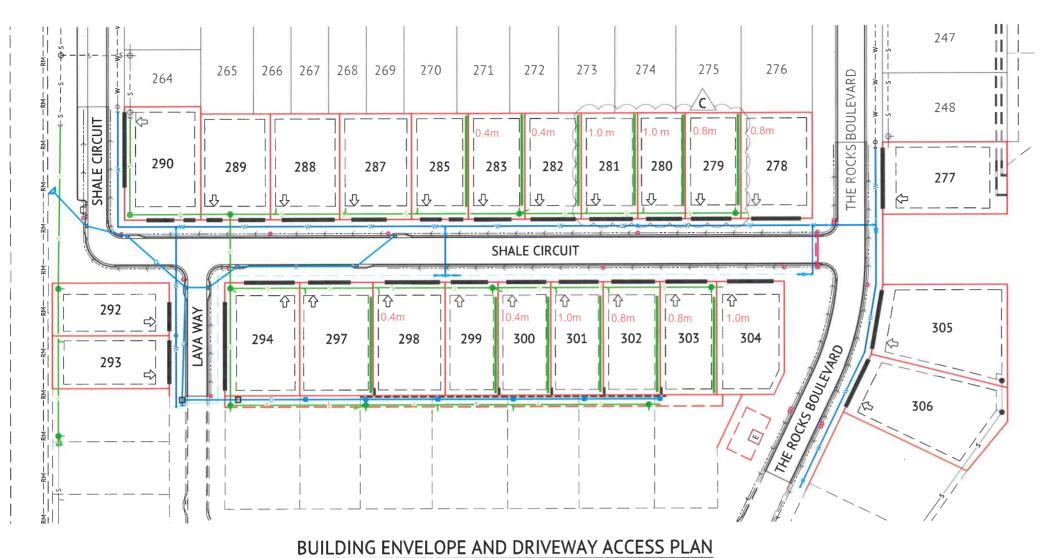

#### **NOTES**

- 1. 60% MAXIMUM SITE COVERAGE.
- FOR FRONT SETBACK TO GARAGE, MEASURE FROM THE FRONT BOUNDARY TO THE GARAGE OPENING (WALL).
- 3. ALL OTHER SETBACKS ARE MEASURED FROM THE BOUNDARY TO THE OUTERMOST PROJECTIONS.


OOTINGS, SLABS AND WALLS OF DWELLING MUST BE DESIGNED AND CONSTRUCTED TO NOT COMPROMISE THE EXISTING RETAINING VALL. ANY PERMANENT LOAD WITHIN 1.5 BY WALL HEIGHT FROM BACK OF RETAINING WALL MUST BE SELF-SUPPORTING WITHOUT SURCHARGING THE RETAINING WALL

FENCE POSTS TO THE REAR OF RETAINING WALLS MUST EXTEND TO DEPTH EQUAL TO EIGHT OF WALL.

X.X m DENOTES WALL HEIGHT


**DENOTES WALL LOCATION** 

#### LIGHT POLES & TELSTRA PITS HAVE NOT BEEN SHOWN AS APPROVED PLANS HAVE NOT BEEN RECEIVED TO DATE

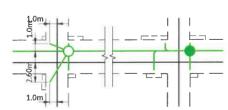

#### HOUSE CONNECTION DETAIL

NOTE: MINIMUM 1.0m CLEARANCE FROM END OF SEWER HOUSE CONNECTION TO THE NEAREST POINT OF THE STRUCTURE FOUNDATION OR 2.0m CLEARANCE FROM CONNECTION AT MAIN/CENTRE OF MANHOLE.

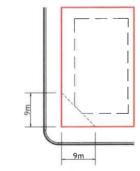

STANDARD CORNER BUILDING SETBACK

SCALE 1:500

#### **LEGEND**

SEWER MAIN & MANHOLE WATER MAIN, FIRE HYDRANT

& SLUICE VALVE STORMWATER DRAINAGE LINE

→ SUBSOIL DRAIN & CLEANOUT POINT

EXISTING SEWER MAIN & MANHOLE

— W—— EXISTING WATER MAIN -D- EXISTING STORMWATER

ALLOWABLE DRIVEWAY ACCESS

BUILT TO BOUNDARY GARAGE AS PER QDC BUILDING SETBACK, REFER NOTE 3

LINK BLOCK RETAINING WALL

EXISTING LINK BLOCK RETAINING WALL

 $\Diamond$ PREFERRED DRIVEWAY LOCATION

E ERGON CABINET LOCATION

#### **DRIVEWAY ACCESS ENVELOPE**

- 1. FOR DRIVEWAY ACCESS ENVELOPE ALLOW 0.5m MINIMUM CLEARANCE TO ALL COUNCIL INFRASTRUCTURE, EXCEPT STORMWATER PITS WHICH REQUIRED 0.6m MINIMUM CLEARANCE AND SEWERAGE HOUSE CONNECTIONS WHICH REQUIRE 1.2m MINIMUM CLEARANCE
- 2. ALL DRIVEWAYS REQUIRED A PERMIT FROM COUNCIL PRIOR TO CONSTRUCTION

#### **CORNER SIGHT LINES**

- 1. COMPLY WITH SIGHT LINES REQUIREMENT OF THE QUEENSLAND AND DEVELOPMENT CODE ON ROAD CORNERS. THIS IS TYPICALLY A 9m x 9m EXCLUSION ZONE BASED ON BOUNDARIES.
- 2 FOR CLOPPED CORNERS AND LOTS WITH PARK FRONT AGES TYPICALLY THIS IS A 18m x 18m EXCLUSION ZONE BASED ON THE EDGE OF THE TRAFFIC LANE. REAR ACCESS LANES ARE EXEMPTED FROM THIS REQUIREMENT.

#### **BUILDING SETBACK**

- 1. "SETBACK" MEANS A LINE OR LINES PARALLEL TO ANY BOUNDARY OF A LOT BEYOND WHICH THE BUILDING OR OTHER STRUCTURE SHALL NOT ENCROACH, AND MEASURED AS THE SHORTEST HORIZONTAL DISTANCE FROM THE OUTERMOST PROJECTION OF THE BUILDING OR OTHER STRUCTURE TO THE VERTICAL PROJECTION OF THE LOT BOUNDARY (TOWNSVILLE CITY PLAN 2005,
- PAGE 491).
  2. THE BUILDING ENVELOPES ARE TO COMPLY WITH THE DESIGN CODE SHOWN ON THIS PLAN. GREATER SETBACKS MAY BE REQUIRED TO ACCOMMODATE THE ZONE OF INFLUENCE OF UNDERGROUND SERVICES AS STATED IN COUNCIL'S POLICY ON BUILDING OVER OR ADJACENT TO SEWERS.
- 3. DIMENSIONS ARE ODC GROUND DWELLING ONLY AND DO NOT ACCOUNT FOR BATTERS OR RETAINING WALLS. A SITE INSPECTION IS REQUIRED PRIOR TO COMMENCEMENT OF DESIGN. REFER DESIGN CODE FOR UPPER FLOOR AND

#### **DESIGN CODE - ALL ALLOTMENTS**

TYPE	HOUSE, FRONT LOADED			
LOT ACCESS	FRONT			
LOT DEPTH (MIN)	25m (20m WHERE 15m WIDTH PROPOSED)			
LOT WIDTH (MIN)	10.0m			
SITE COVERAGE	MAY EXCEED 50% IN RESPONSE TO CODE REQUIREMENTS BUT NO MORE THAN 60% SITE COVERAGE.			
SETBACK FRONT GROUND (MIN) AND UPPER (MIN)	3.5m			
SETBACK FRONT GARAGE	6m AND 1.5m BEHIND FRONT OF DWELLING			
SETBACK PRINCIPAL SIDE GROUND (MIN)	QUEENSLAND DEVELOPMENT CODE  QUEENSLAND DEVELOPMENT CODE  2m  1.5m (SEWER LINES AND MANHOLES MAY ENFORCE GREATER SETBACKS)*			
SETBACK PRINCIPAL SIDE UPPER (MIN)				
SETBACK SECONDARY ROAD FRONTAGE (MIN)				
SETBACK PRINCIPAL REAR (MIN)				
OUTBUILDING (SHED) WIDTH (MAX)	LESSER OF 50% OF REAR BOUNDARY OR 9m			
OUTBUILDING (SHED) DEPTH (MAX)	9m			
OUTBUILDING (SHED) REAR SETBACK	0-1.0m			
OUTBUILDING (SHED) SIDE SETBACK	ZERO IF LOT 12.5m WIDE. AS PER PRINCIPAL SETBACK IF LOT >12.5m WIDE			
FLOOR HEIGHT PRINCIPAL (MIN)	400mm			
MAXIMUM STOREYS	AS PER THE APPLICABLE SCHEME			
PRIVATE OPEN SPACE (MIN) (MAY BE COVERED)	4mx4m			
PARKING (MIN)	TWO (2), ONE OF WHICH MUST BE COVERED			

### FOR CONSTRUCTION

LOT 280 ADDED, LOTS 281 AND 279 AMENDED TO SUIT 14/09/20 REVISED LOT LAYOUT
REVISED LOT LAYOUT 17/12/19 ISSUED FOR OPERATIO 26/06/18 1 PRELIMINARY IS: DATE REV DESCRIPTION

Premise

**TOWNSVILLE OFFICE** 84 DENHAM STREET PO BOX 1110 TOWNSVILLE, QLD 4810 PH: (07) 4772 0666 WEB: www.premise.com.au

G.CAMPBELL G.FYSH SCALE 1:500 (A1) P.PETERSEN RPEQ 13231 ORIGINAL SHEET SIZE A1

PARKSIDE DEVELOPMENT PTY LTD PROJECT COSGROVE - STAGE 206

LOCATION COSGROVE DRIVE - COSGROVE

SHEET TITLE BUILDING ENVELOPE AND DRIVEWAY ACCESS PLAN

PAR-0220

C019